

LOCATION PLAN SCALE: 1" = 2,000'±


WILDLIFE PROTECTION NOTES (ENV-WQ 1504.17)

- ALL OBSERVATIONS OF THREATENED OR ENDANGERED SPECIES SHALL BE REPORTED IMMEDIATELY TO THE NEW HAMPSHIRE FISH AND GAME DEPARTMENT NONGAME AND ENDANGERED WILDLIFE ENVIRONMENTAL REVIEW PROGRAM BY PHONE AT 603-271-2461 AND BY EMAIL AT <u>NHFGREVIEW@WILDLIFE.NH.GOV</u>. EMAIL SUBJECT LINE: NHB24-0767, JENNESSTOWN MANOR, WILDLIFE SPECIES OBSERVATION.
 PHOTOGRAPHS OF THE OBSERVED SPECIES AND NEARBY ELEMENTS OF HABITAT OR AREAS OF LAND
- DISTURBANCE SHALL BE PROVIDED TO NHF&G IN DIGITAL FORMAT FOR VERIFICATION AS FEASIBLE; IN THE EVENT A THREATENED OR ENDANGERED SPECIES IS OBSERVED ON THE PROJECT SITE DURING THE TERM
- OF THE PERMIT, THE SPECIES SHALL NOT BE DISTURBED, HANDLED, OR HARMED IN ANY WAY PRIOR TO CONSULTATION WITH NHF&G AND IMPLEMENTATION OF CORRECTIVE ACTIONS RECOMMENDED BY NHF&G, IF ANY, TO ASSURE THE PROJECT DOES NOT APPRECIABLY JEOPARDIZE THE CONTINUED EXISTENCE OF THREATENED AND ENDANGERED SPECIES AS DEFINED IN FIS 1002.04 THE NHF&G. INCLUDING ITS EMPLOYEES AND AUTHORIZED AGENTS, SHALL HAVE ACCESS TO THE PROPERTY

RESIDENTIAL SITE PLAN JENNESSTOWN MANOR


MAP 7; LOTS 39 & 39-1 ROUTE 103

WARNER, NEW HAMPSHIRE

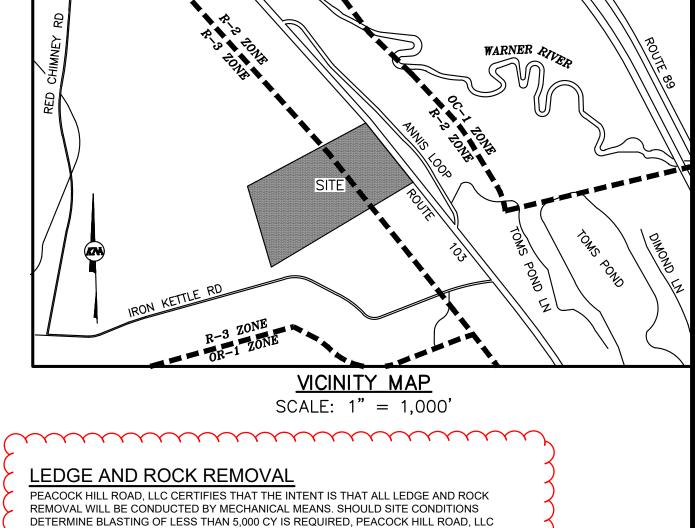

CERTIFIES BLASTING BEST MANAGEMENT PRACTICES OUTLINED IN ENV-WQ 1510 WILL BE FOLLOWED. NO BLASTING IN EXCESS OF 5,000 CY IS PERMITTED WITHOUT CONTACTING THE DESIGN ENGINEER AND NHDES ALTERATION OF TERRAIN.

GARY FITZGERALD, MEMBER

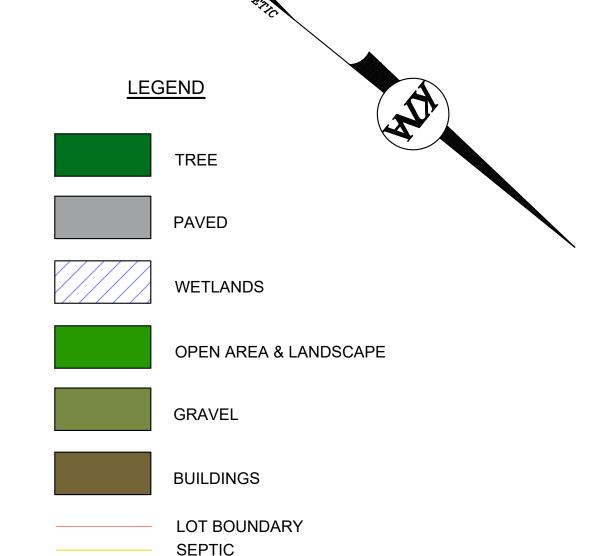

WELL RADIUS



SITE PLAN SCALE: 1" = 40'

OWNER/APPLICANT: PEACOCK HILL ROAD, LLC 145 OLD TOWN ROAD WEARE, NH 03281

ENGINEER:

KEACH-NORDSTROM ASSOCIATES, INC. 10 COMMERCE PARK NORTH, SUITE 3B BEDFORD, NEW HAMPSHIRE 03110 (603) 627-2881


SURVEYOR:


J.E. BELANGER LAND SURVEYING PLLC 61 OLD HOPKINTON ROAD DUNBARTON, NEW HAMPSHIRE 03046 (603) 774-3601

DIG SAFF J.E. BELANGER LAND SURVEYING PLLC LICENSED LAND SURVEYOR 61 OLD HOPKINTON ROAD, DUNBARTON, NH 03046 * BOUNDARY SURVEYS * SUBDIVISIONS

MARCH 25, 2024 REVISED MAY 22, 2025 PROJECT NO. 24-0307-1

SHEET TITLE	HEET No.	
EXISTING CONDITIONS PLAN	1 - 2	
SITE PLAN	3	
EASEMENT PLAN	4	
GRADING, DRAINAGE & UTILITY PLAN	5	
EROSION CONTROL PLAN	6	
LANDSCAPE PLAN	7	
LIGHTING PLAN	8	
SITE VISIBILITY FROM ROAD PLAN & PROFILE	9	
SIGHT DISTANCE PLAN	10	
DRIVEWAY PROFILE PLAN	11	
CONSTRUCTION DETAILS	12 - 16	
ARCHITECTURAL DRAWINGS	A1 - A5	

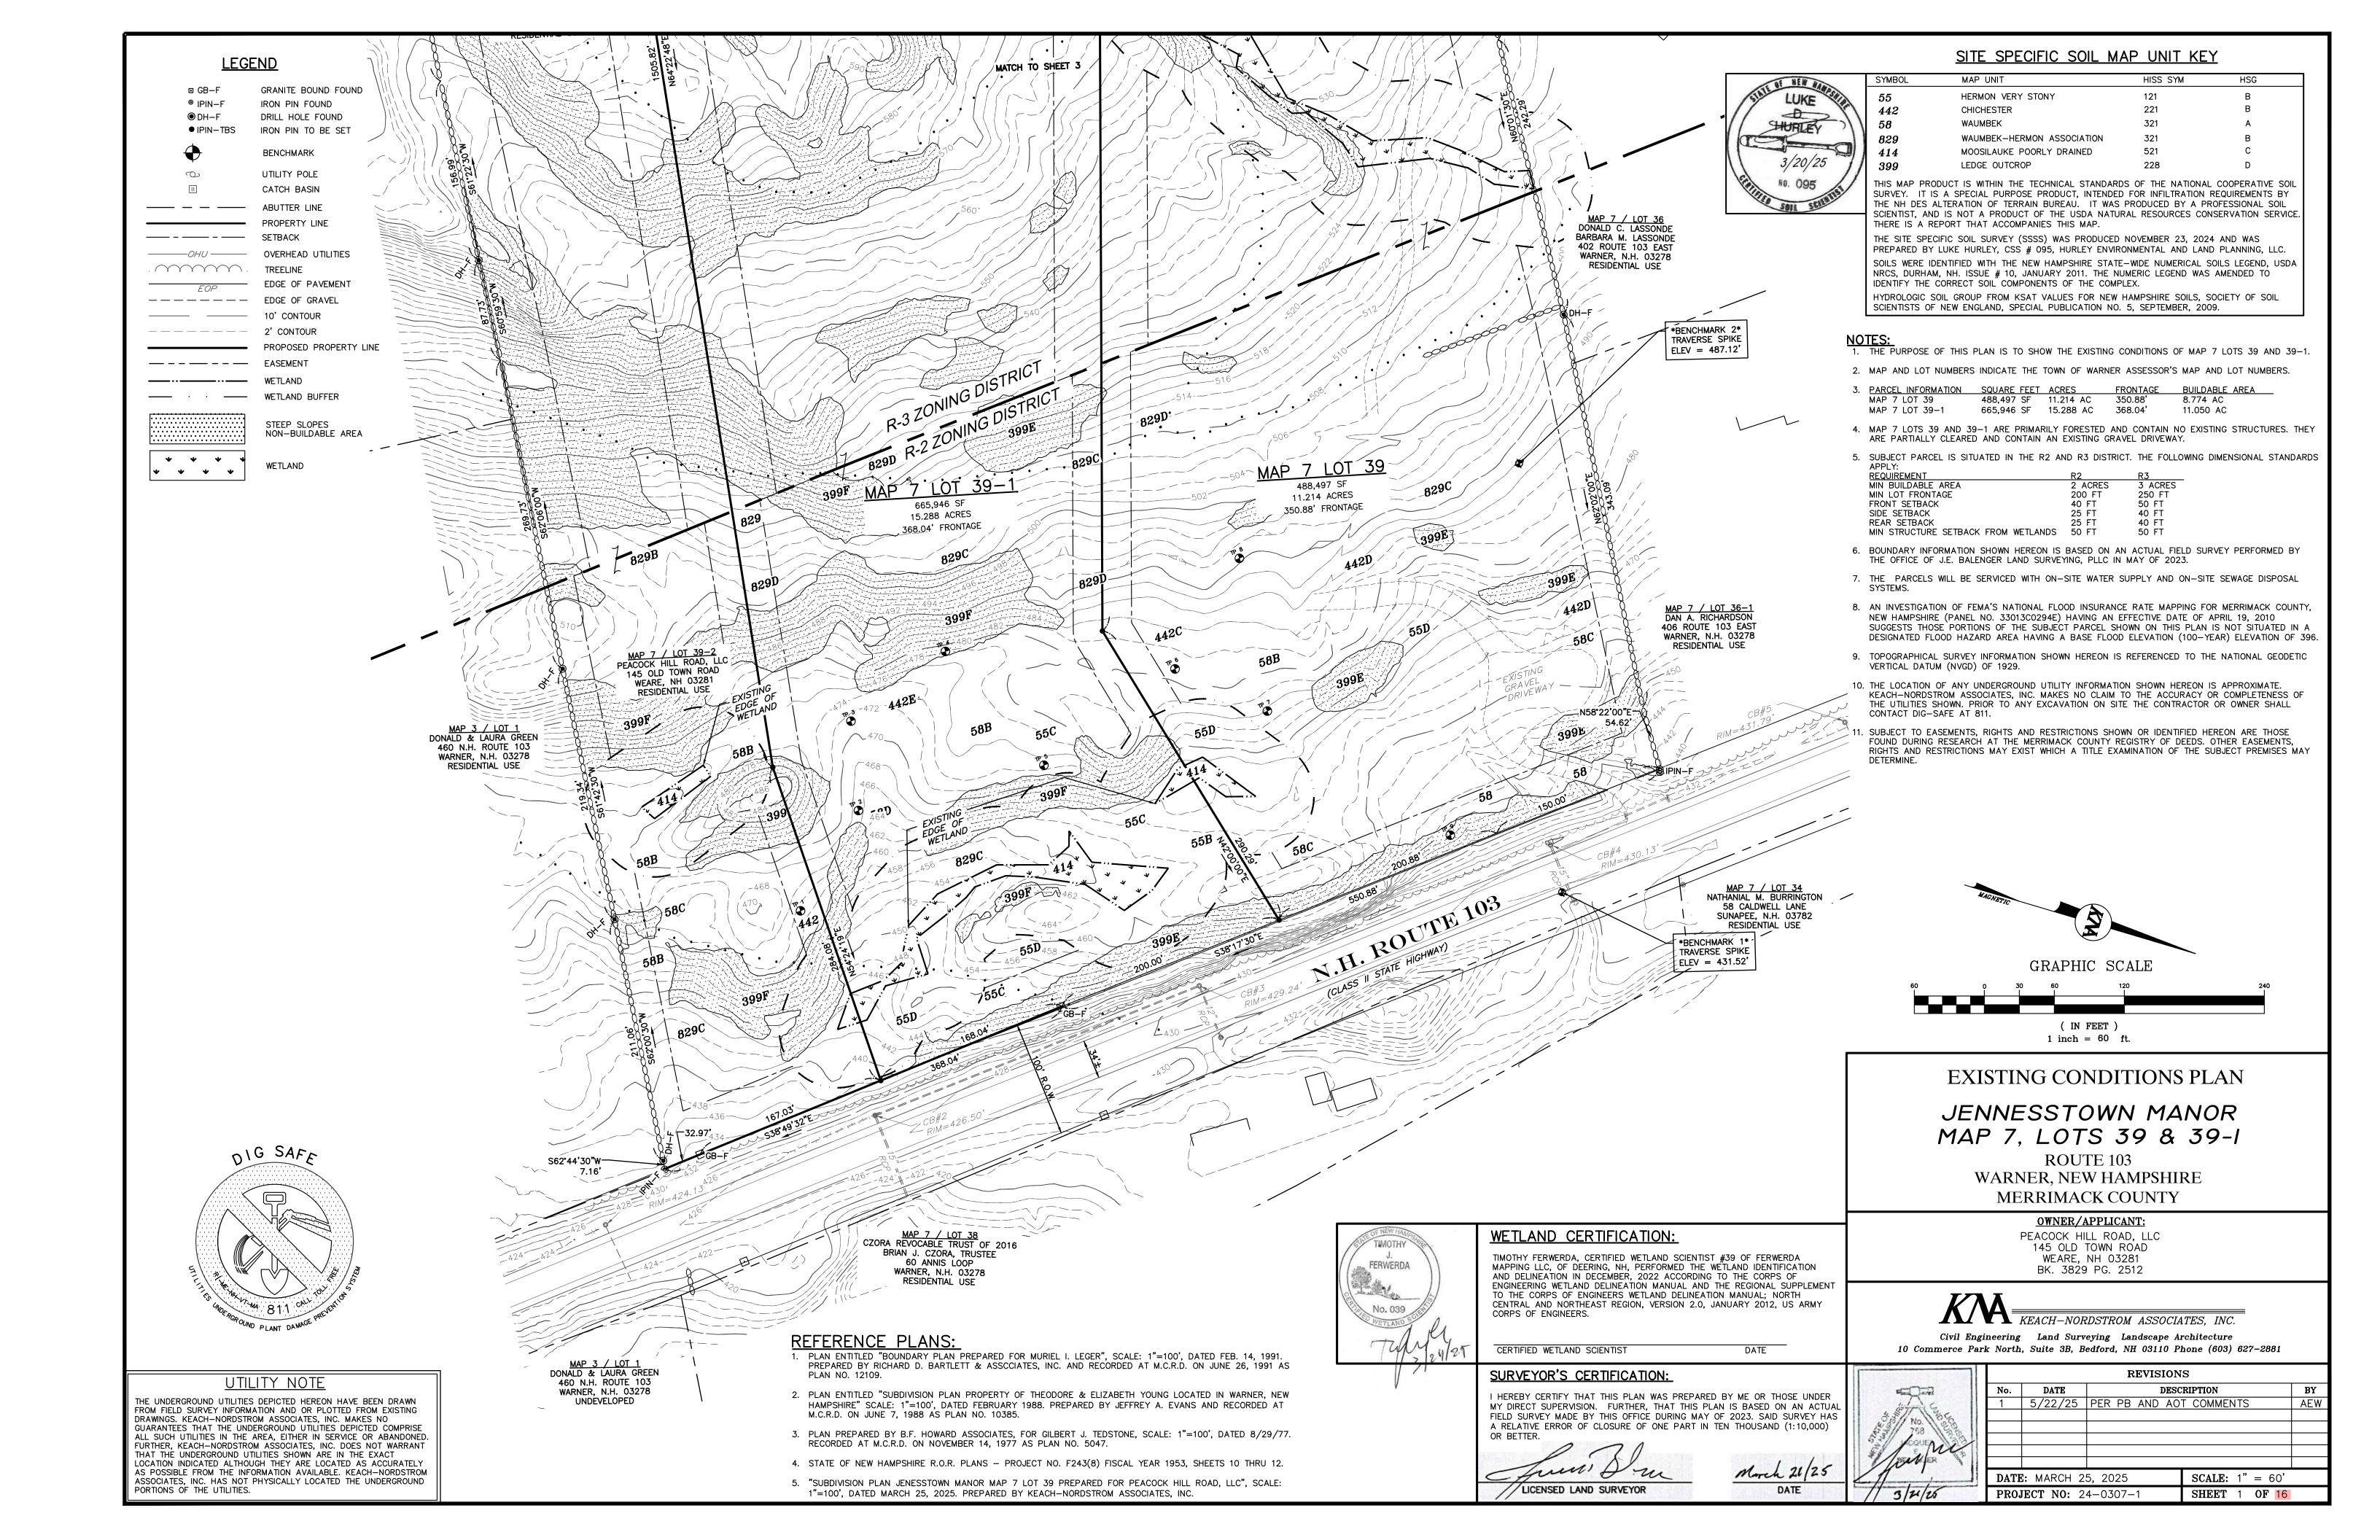

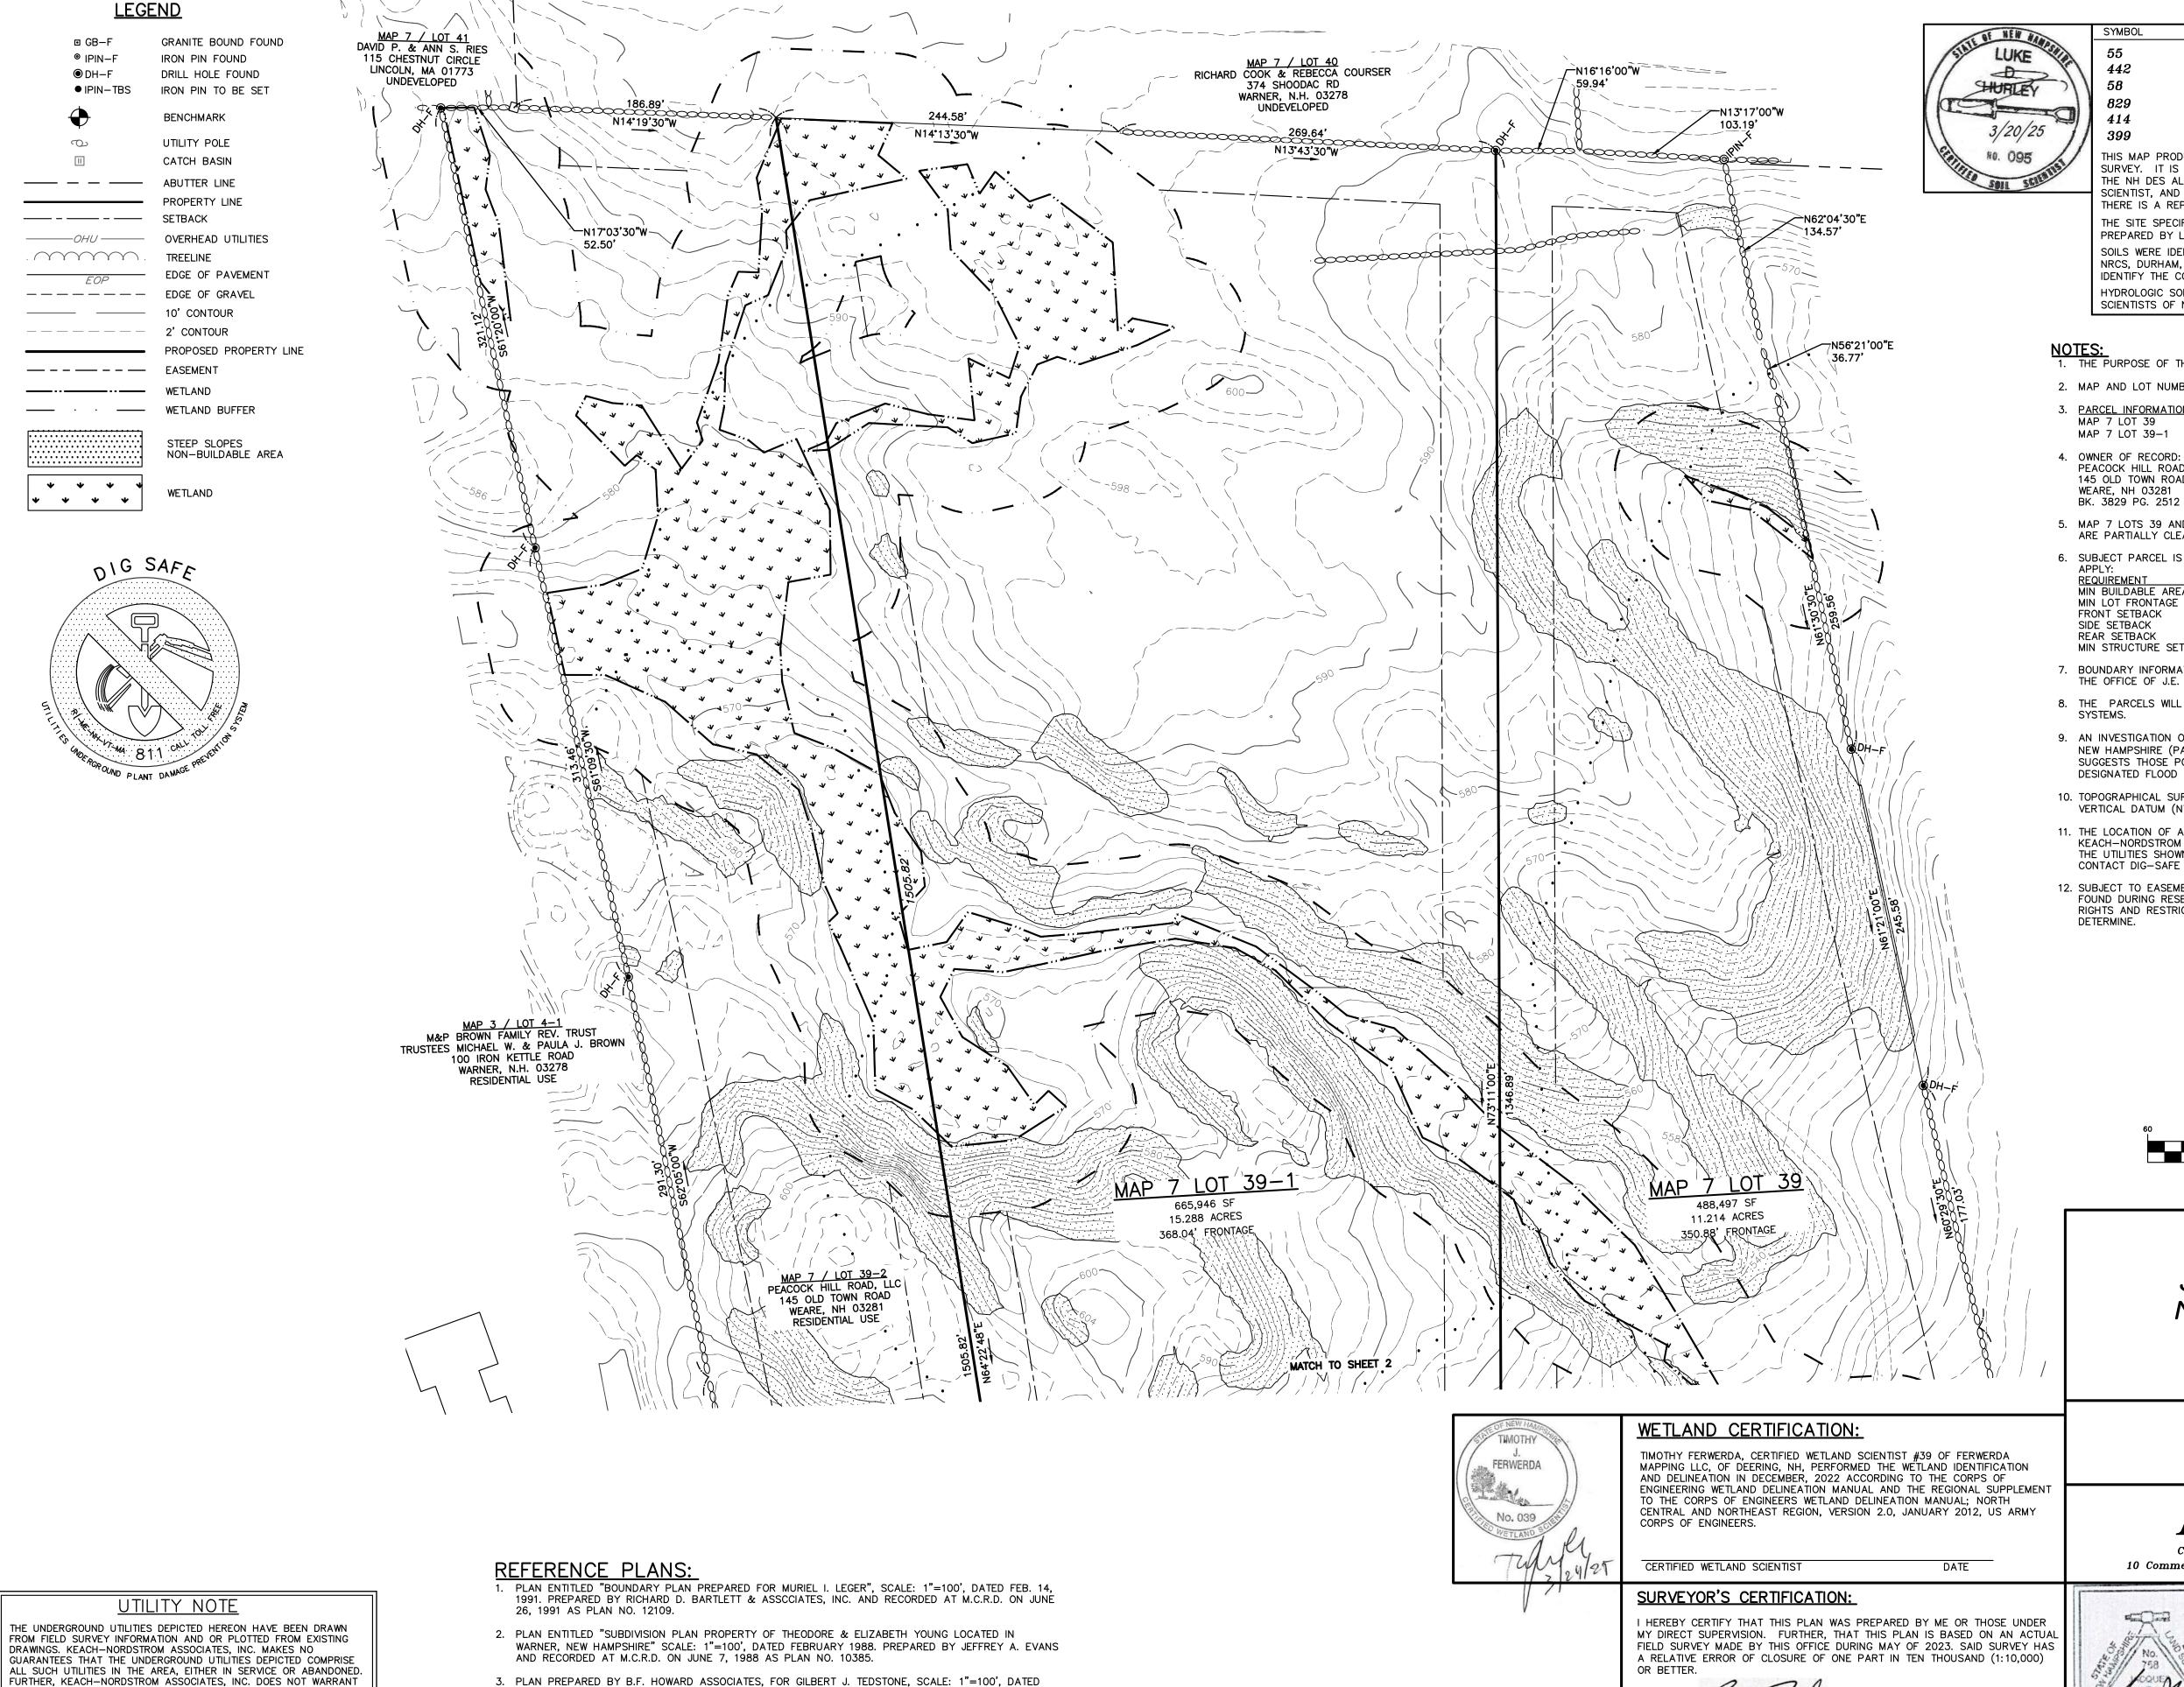

8/29/77. RECORDED AT M.C.R.D. ON NOVEMBER 14, 1977 AS PLAN NO. 5047.

4. STATE OF NEW HAMPSHIRE R.O.R. PLANS - PROJECT NO. F243(8) FISCAL YEAR 1953, SHEETS 10

THAT THE UNDERGROUND UTILITIES SHOWN ARE IN THE EXACT

PORTIONS OF THE UTILITIES.

LOCATION INDICATED ALTHOUGH THEY ARE LOCATED AS ACCURATELY

AS POSSIBLE FROM THE INFORMATION AVAILABLE. KEACH-NORDSTROM

ASSOCIATES, INC. HAS NOT PHYSICALLY LOCATED THE UNDERGROUND

SITE SPECIFIC SOIL MAP UNIT KEY

MAP UNIT HISS SYM HSG HERMON VERY STONY CHICHESTER WAUMBEK WAUMBEK-HERMON ASSOCIATION MOOSILAUKE POORLY DRAINED LEDGE OUTCROP

THIS MAP PRODUCT IS WITHIN THE TECHNICAL STANDARDS OF THE NATIONAL COOPERATIVE SOIL SURVEY. IT IS A SPECIAL PURPOSE PRODUCT, INTENDED FOR INFILTRATION REQUIREMENTS BY THE NH DES ALTERATION OF TERRAIN BUREAU. IT WAS PRODUCED BY A PROFESSIONAL SOIL SCIENTIST, AND IS NOT A PRODUCT OF THE USDA NATURAL RESOURCES CONSERVATION SERVICE. THERE IS A REPORT THAT ACCOMPANIES THIS MAP.

THE SITE SPECIFIC SOIL SURVEY (SSSS) WAS PRODUCED NOVEMBER 23, 2024 AND WAS PREPARED BY LUKE HURLEY, CSS # 095, HURLEY ENVIRONMENTAL AND LAND PLANNING, LLC. SOILS WERE IDENTIFIED WITH THE NEW HAMPSHIRE STATE-WIDE NUMERICAL SOILS LEGEND, USDA NRCS, DURHAM, NH. ISSUE # 10, JANUARY 2011. THE NUMERIC LEGEND WAS AMENDED TO IDENTIFY THE CORRECT SOIL COMPONENTS OF THE COMPLEX.

HYDROLOGIC SOIL GROUP FROM KSAT VALUES FOR NEW HAMPSHIRE SOILS, SOCIETY OF SOIL SCIENTISTS OF NEW ENGLAND, SPECIAL PUBLICATION NO. 5, SEPTEMBER, 2009.


NOTES:

1. THE PURPOSE OF THIS PLAN IS TO SHOW THE EXISTING CONDITIONS OF MAP 7 LOTS 39 AND 39-1.

- 2. MAP AND LOT NUMBERS INDICATE THE TOWN OF WARNER ASSESSOR'S MAP AND LOT NUMBERS.
- 3. PARCEL INFORMATION SQUARE FEET ACRES FRONTAGE BUILDABLE AREA 488,497 SF 11.214 AC 350.88'
- MAP 7 LOT 39-1 665,946 SF 15.288 AC 368.04'
- PEACOCK HILL ROAD, LLC 145 OLD TOWN ROAD
- BK. 3829 PG. 2512
- 5. MAP 7 LOTS 39 AND 39-1 ARE PRIMARILY FORESTED AND CONTAIN NO EXISTING STRUCTURES. THEY ARE PARTIALLY CLEARED AND CONTAIN AN EXISTING GRAVEL DRIVEWAY.
- 6. SUBJECT PARCEL IS SITUATED IN THE R2 AND R3 DISTRICT. THE FOLLOWING DIMENSIONAL STANDARDS

INE QUINE MIE IN I	1\Z	110
MIN BUILDABLE AREA	2 ACRES	3 ACRES
MIN LOT FRONTAGE	200 FT	250 FT
FRONT SETBACK	40 FT	50 FT
SIDE SETBACK	25 FT	40 FT
REAR SETBACK	25 FT	40 FT
MIN STRUCTURE SETBACK FROM WETLANDS	50 FT	50 FT

- 7. BOUNDARY INFORMATION SHOWN HEREON IS BASED ON AN ACTUAL FIELD SURVEY PERFORMED BY THE OFFICE OF J.E. BALENGER LAND SURVEYING, PLLC IN MAY OF 2023.
- 8. THE PARCELS WILL BE SERVICED WITH ON-SITE WATER SUPPLY AND ON-SITE SEWAGE DISPOSAL
- 9. AN INVESTIGATION OF FEMA'S NATIONAL FLOOD INSURANCE RATE MAPPING FOR MERRIMACK COUNTY, NEW HAMPSHIRE (PANEL NO. 33013C0294E) HAVING AN EFFECTIVE DATE OF APRIL 19, 2010 SUGGESTS THOSE PORTIONS OF THE SUBJECT PARCEL SHOWN ON THIS PLAN IS NOT SITUATED IN A DESIGNATED FLOOD HAZARD AREA HAVING A BASE FLOOD ELEVATION (100-YEAR) ELEVATION OF 396.
- 10. TOPOGRAPHICAL SURVEY INFORMATION SHOWN HEREON IS REFERENCED TO THE NATIONAL GEODETIC VERTICAL DATUM (NVGD) OF 1929.
- 11. THE LOCATION OF ANY UNDERGROUND UTILITY INFORMATION SHOWN HEREON IS APPROXIMATE. KEACH-NORDSTROM ASSOCIATES, INC. MAKES NO CLAIM TO THE ACCURACY OR COMPLETENESS OF THE UTILITIES SHOWN. PRIOR TO ANY EXCAVATION ON SITE THE CONTRACTOR OR OWNER SHALL CONTACT DIG-SAFE AT 811.
- 12. SUBJECT TO EASEMENTS, RIGHTS AND RESTRICTIONS SHOWN OR IDENTIFIED HEREON ARE THOSE FOUND DURING RESEARCH AT THE MERRIMACK COUNTY REGISTRY OF DEEDS. OTHER EASEMENTS, RIGHTS AND RESTRICTIONS MAY EXIST WHICH A TITLE EXAMINATION OF THE SUBJECT PREMISES MAY

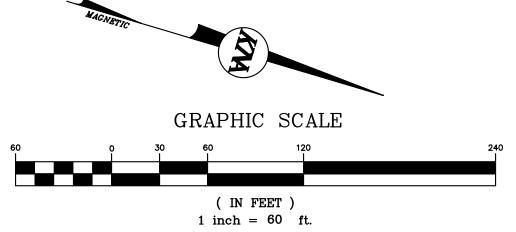

EXISTING CONDITIONS PLAN

JENNESSTOWN MANOR MAP 7, LOTS 39 & 39-1

> ROUTE 103 WARNER, NEW HAMPSHIRE MERRIMACK COUNTY

OWNER/APPLICANT:

PEACOCK HILL ROAD, LLC 145 OLD TOWN ROAD WEARE, NH 03281 BK. 3829 PG. 2512





March 21/25


LICENSED LAND SURVEYOR


■ KEACH-NORDSTROM ASSOCIATES, INC.


	REVISIONS			
404	No.	DATE	I	DESCRIPTION
400	1	5/22/25	PER PB AND	AOT COMMENTS
35 No 186				
758 158				
LOQUED JES				
1 miles				
	DATE	E: MARCH 2	5, 2025	SCALE: 1" =
3/2/25	PROJ	JECT NO: 2	4-0307-1	SHEET 2 OF

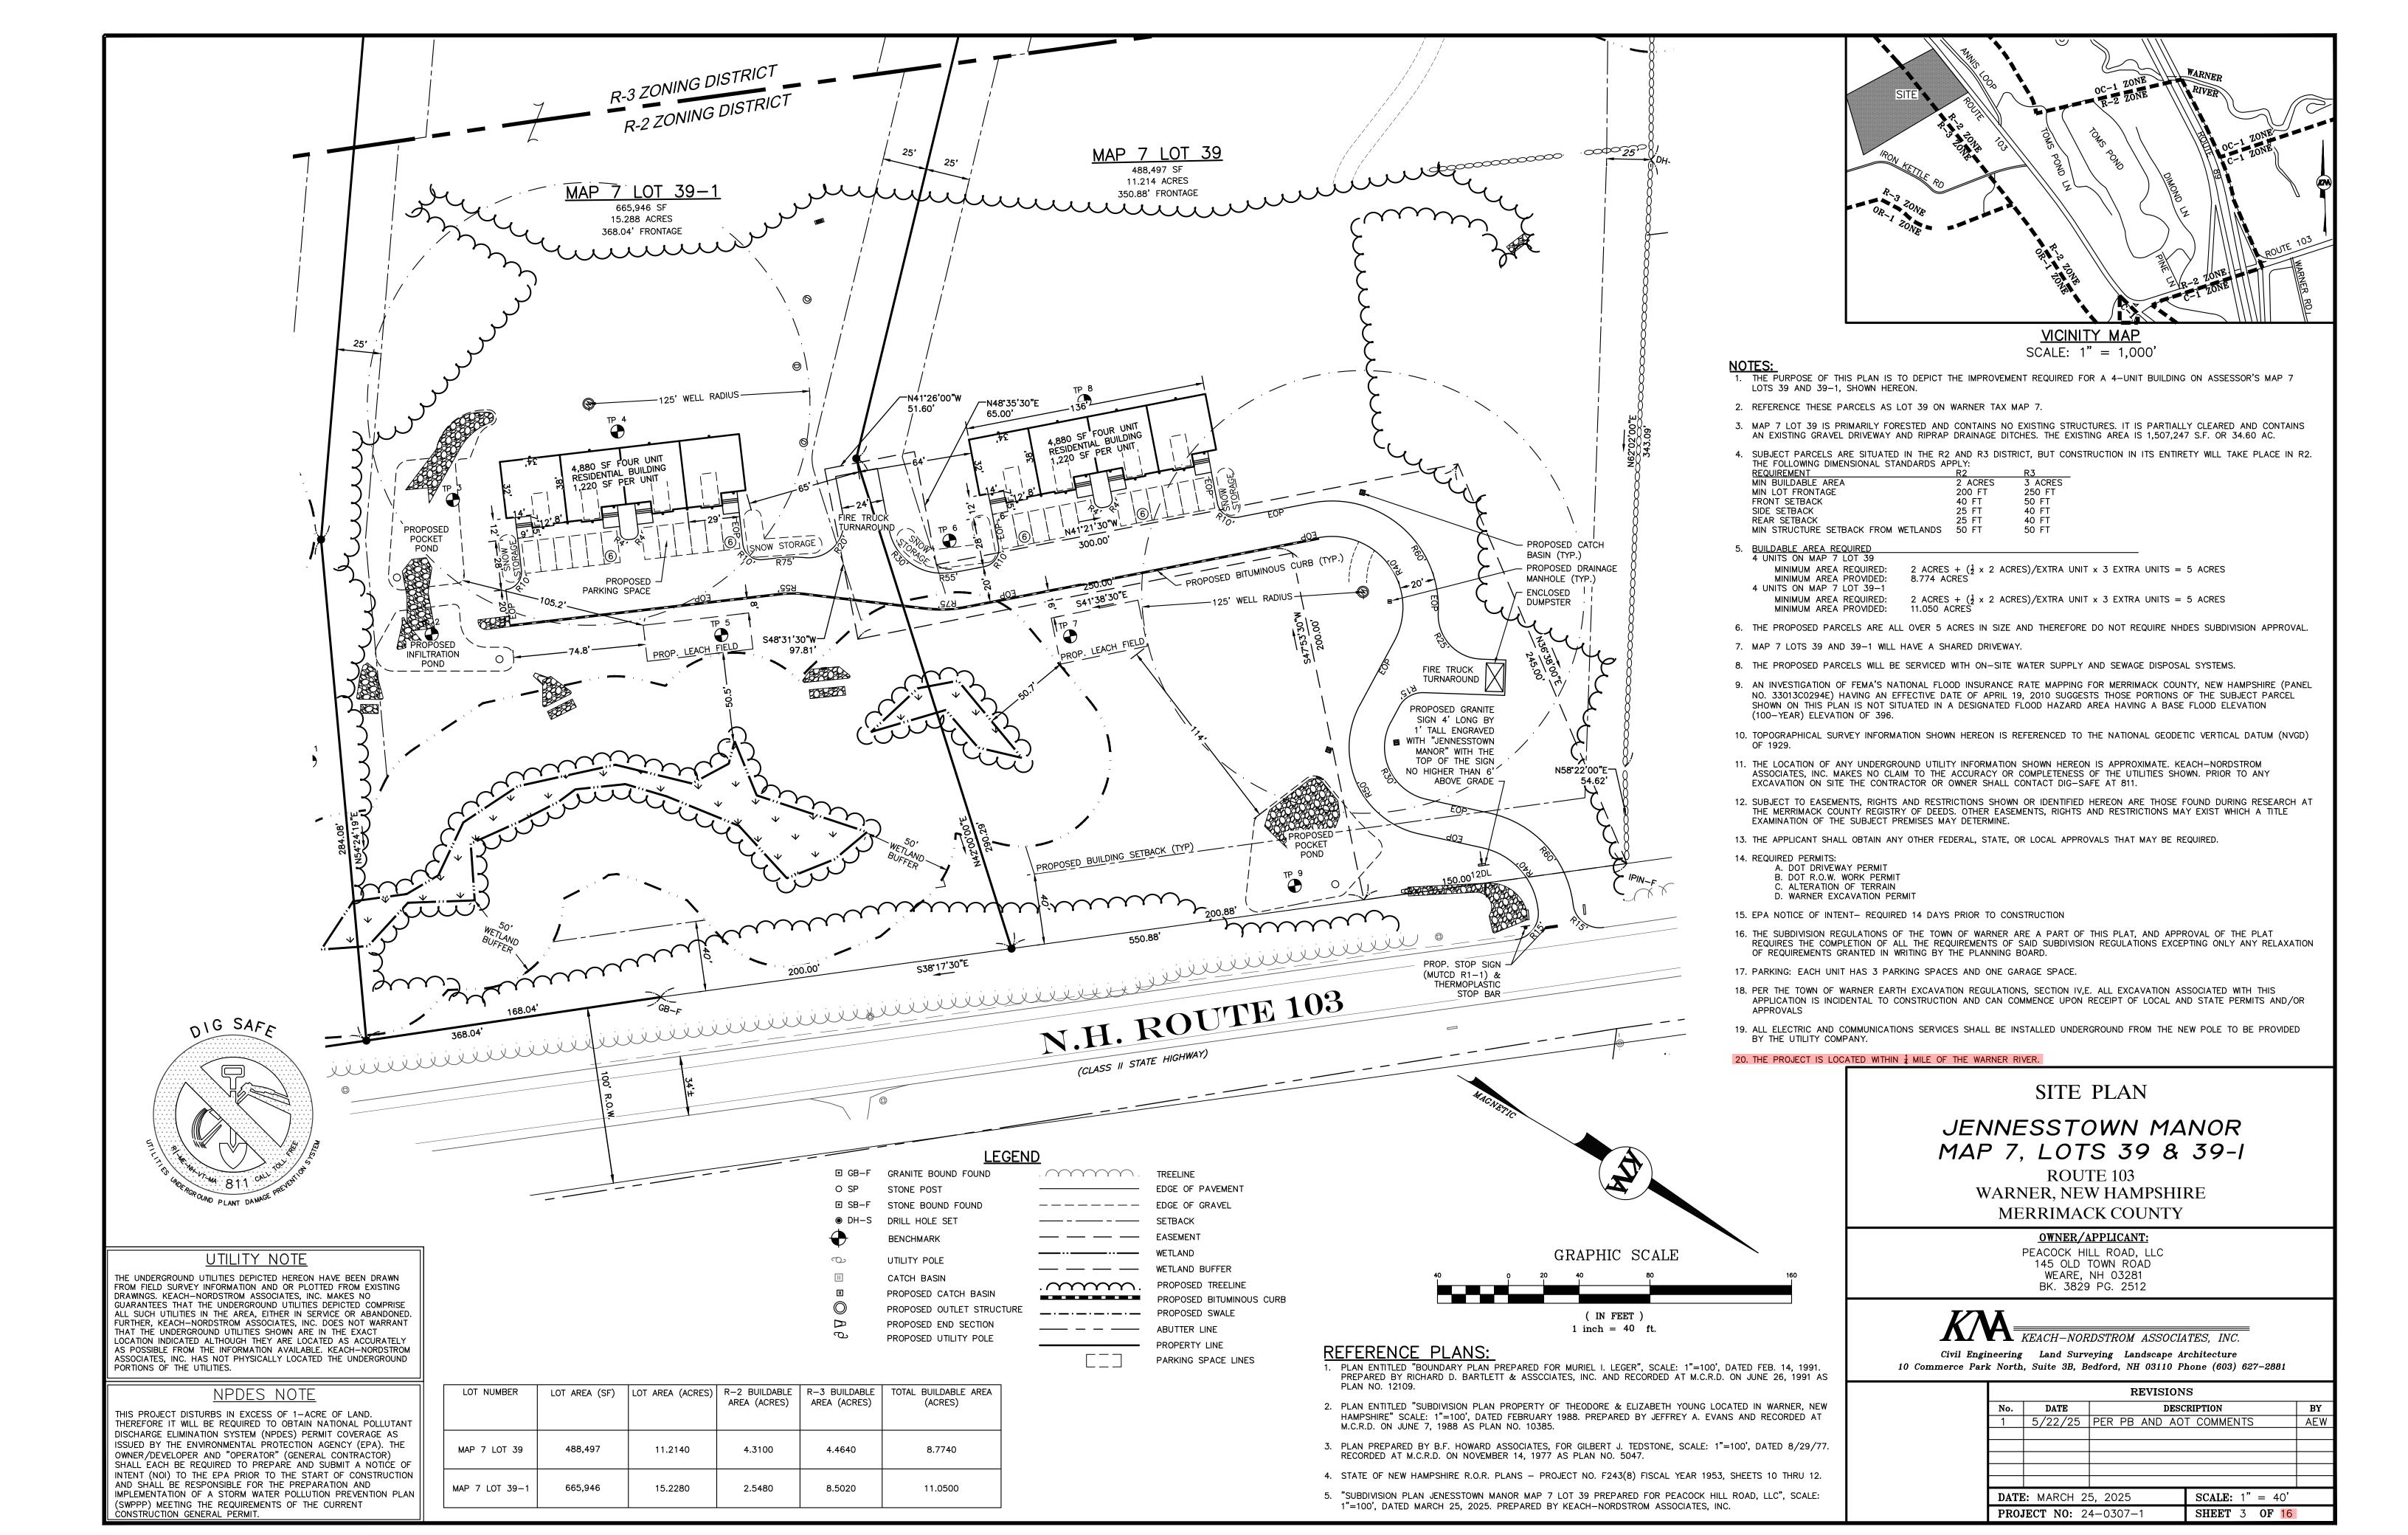

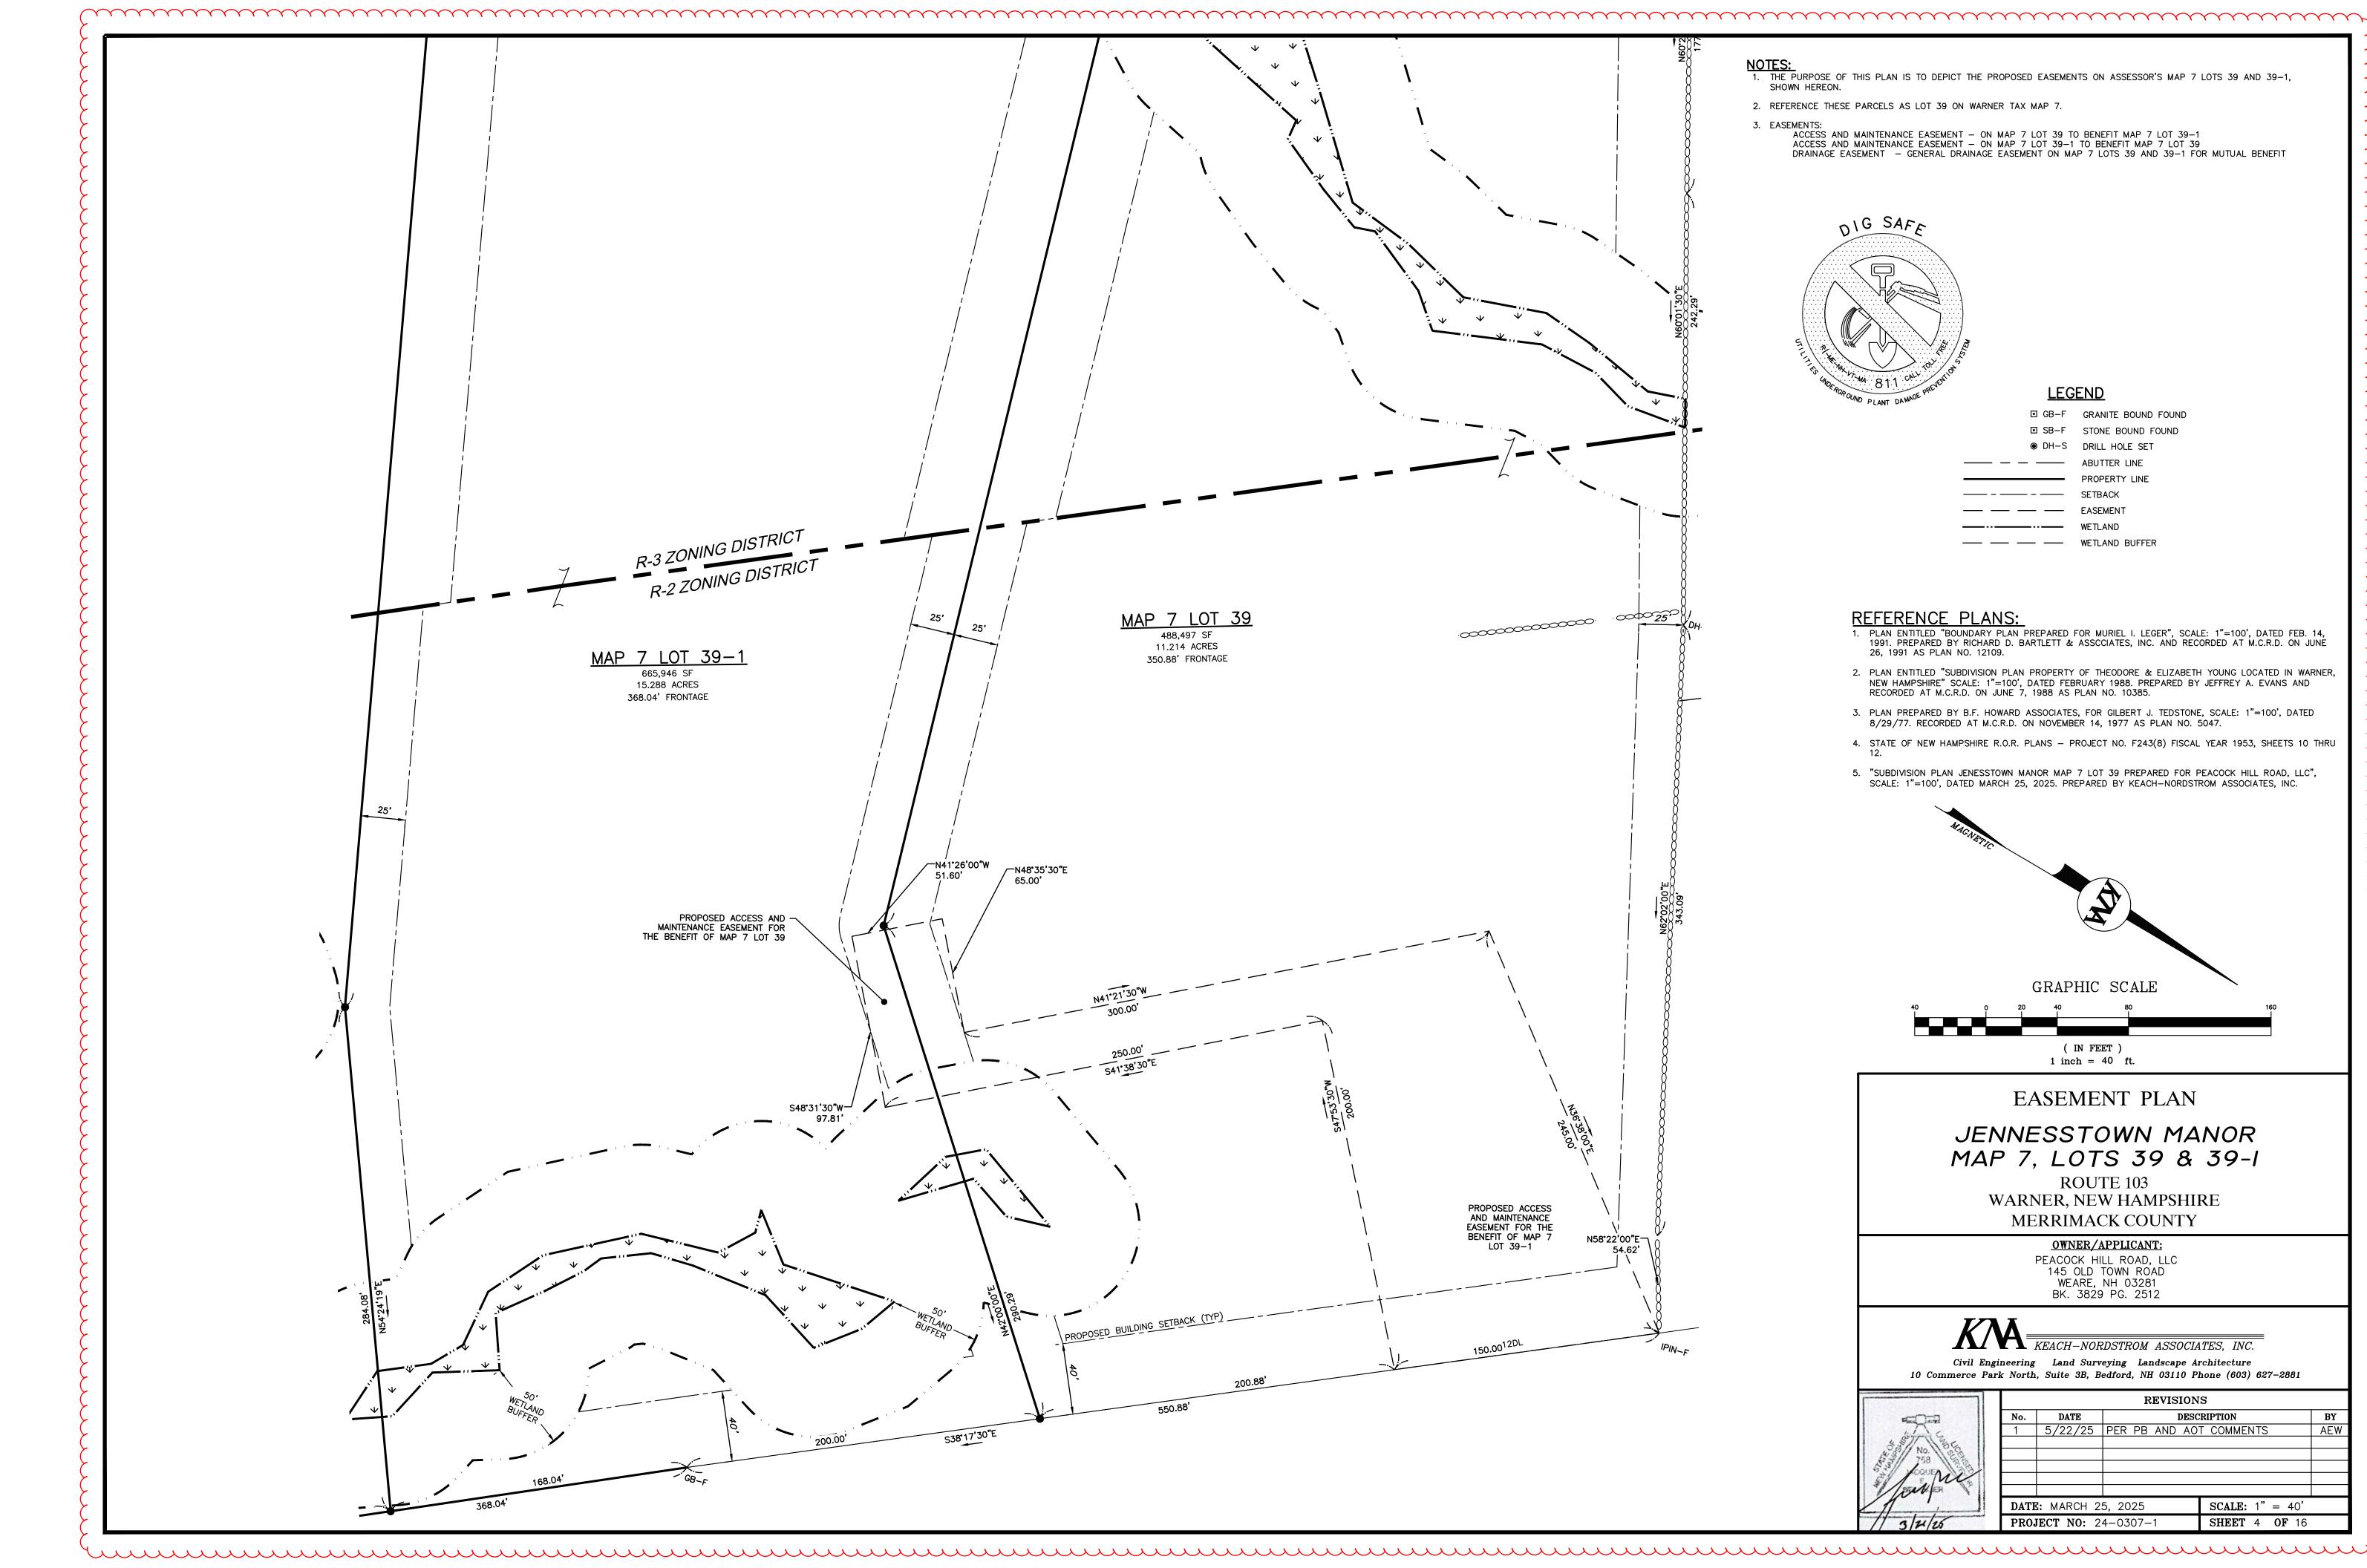

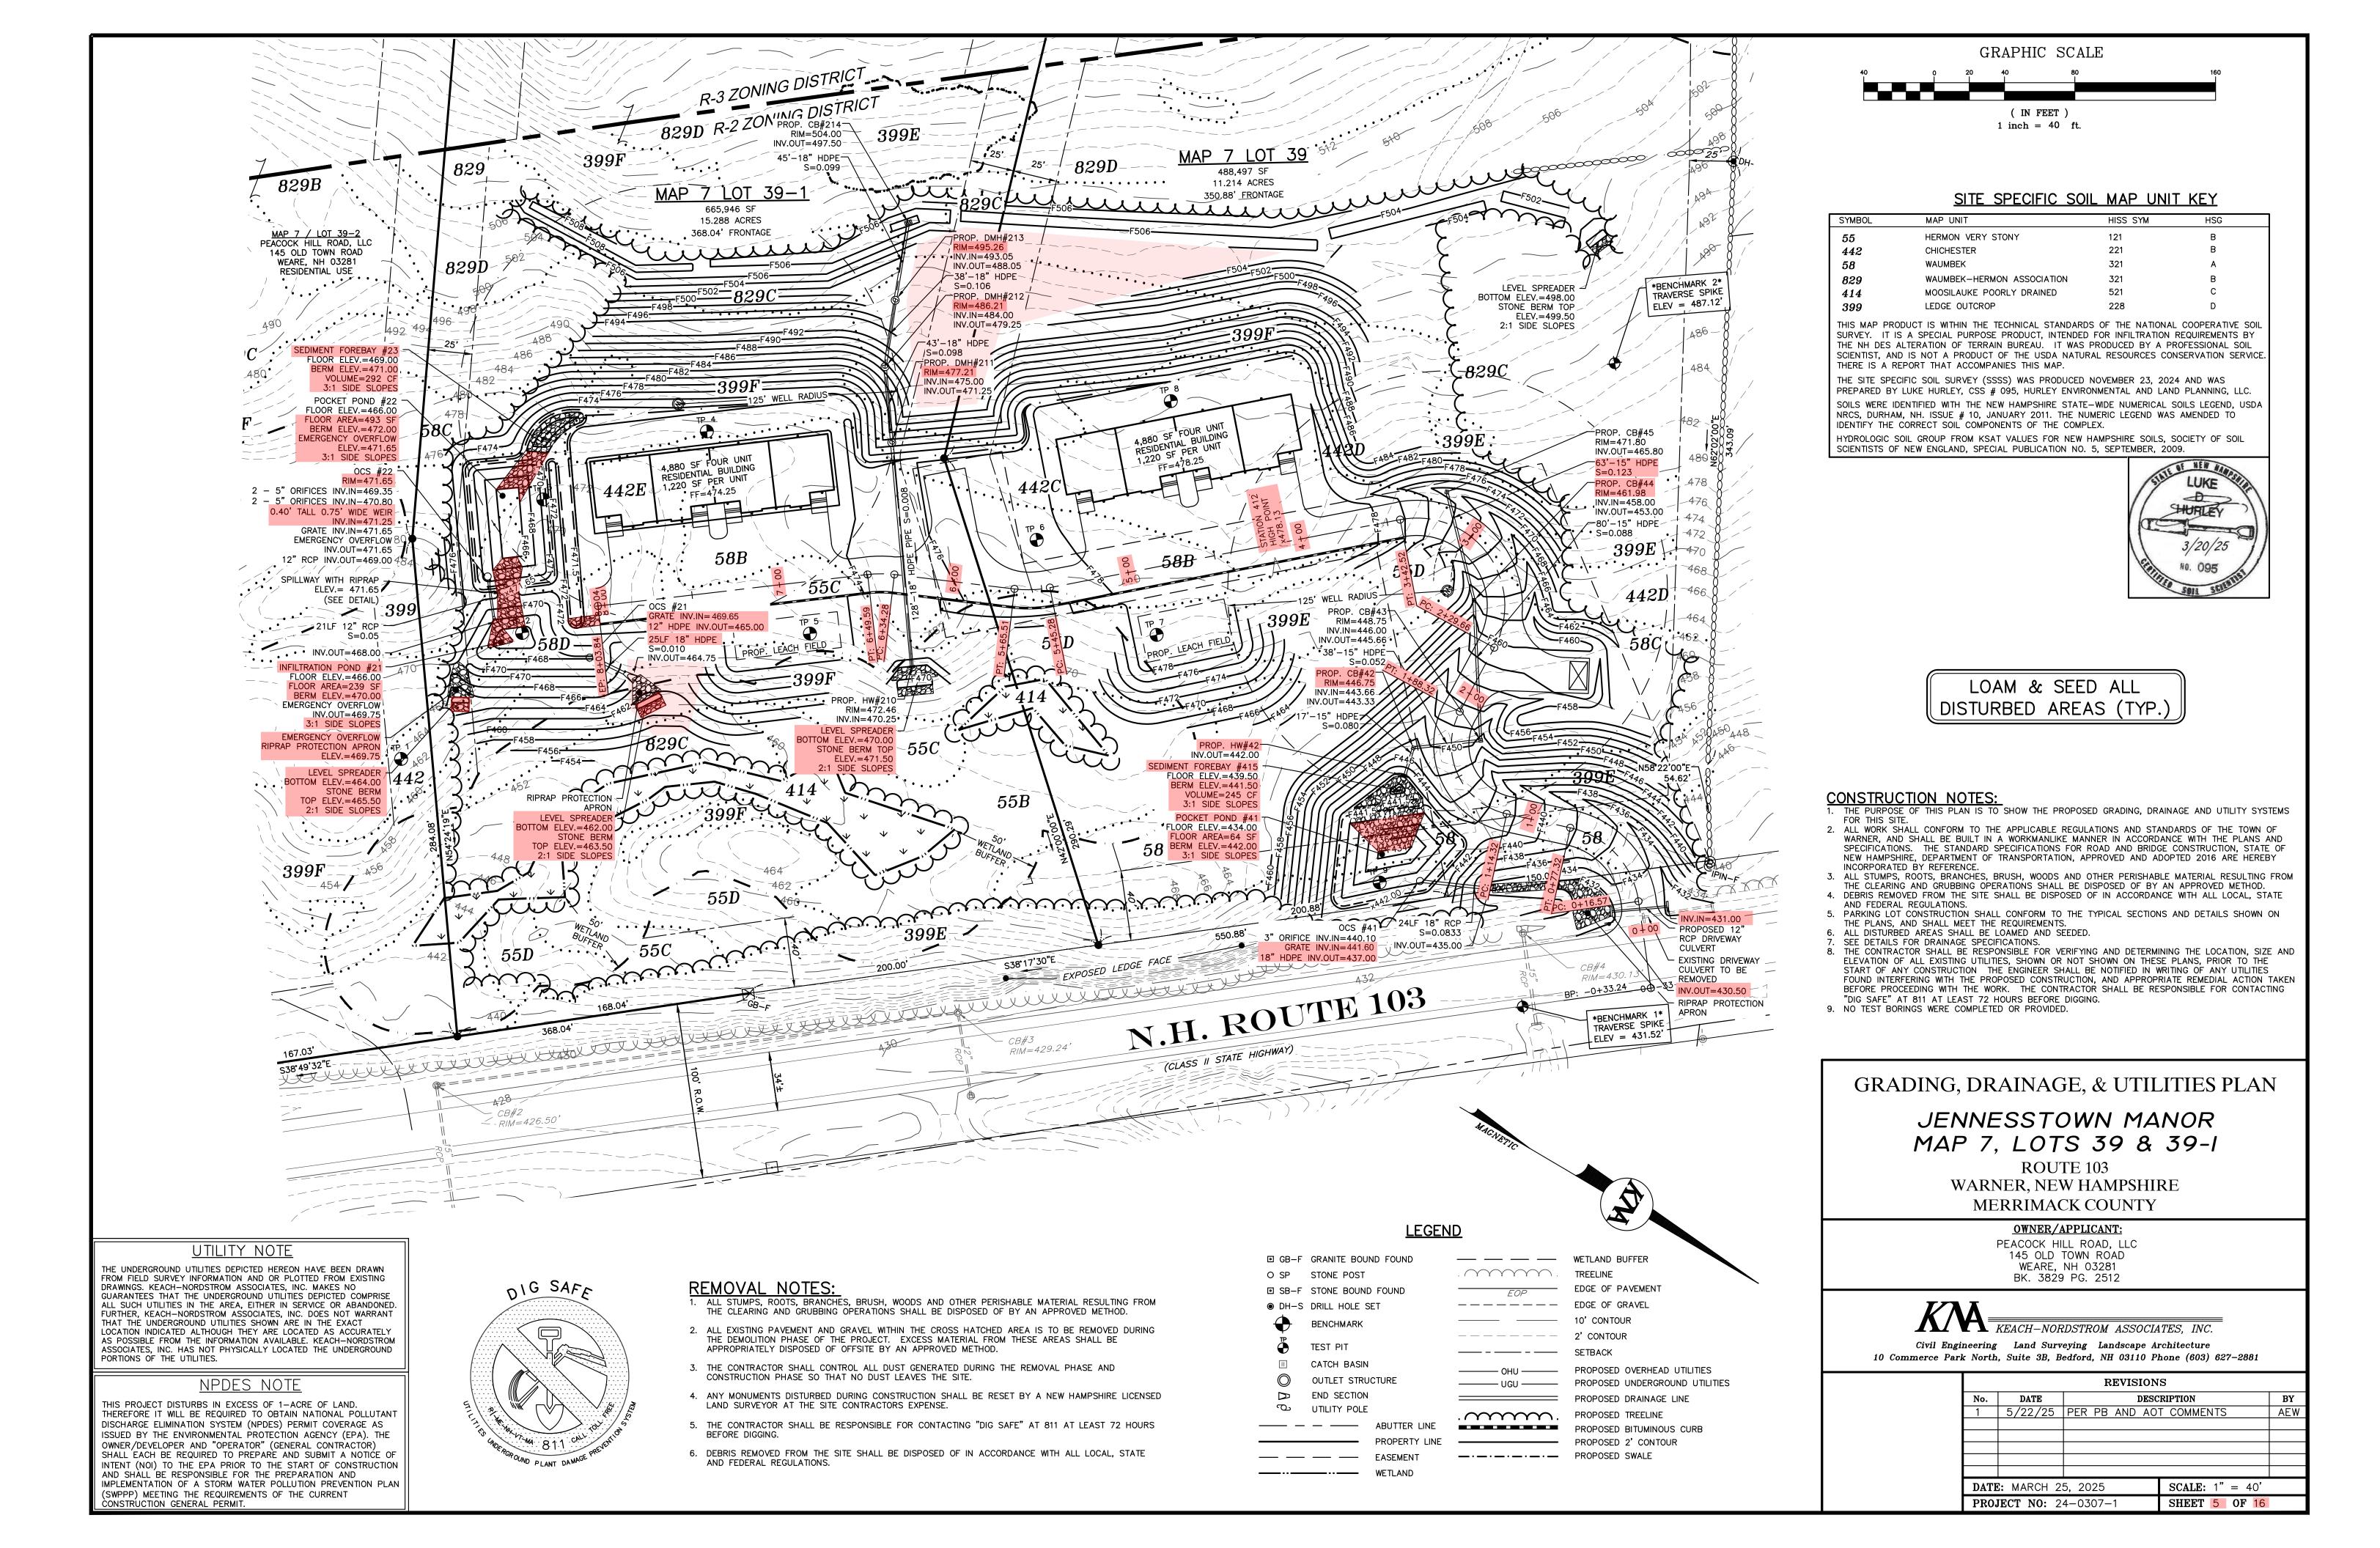


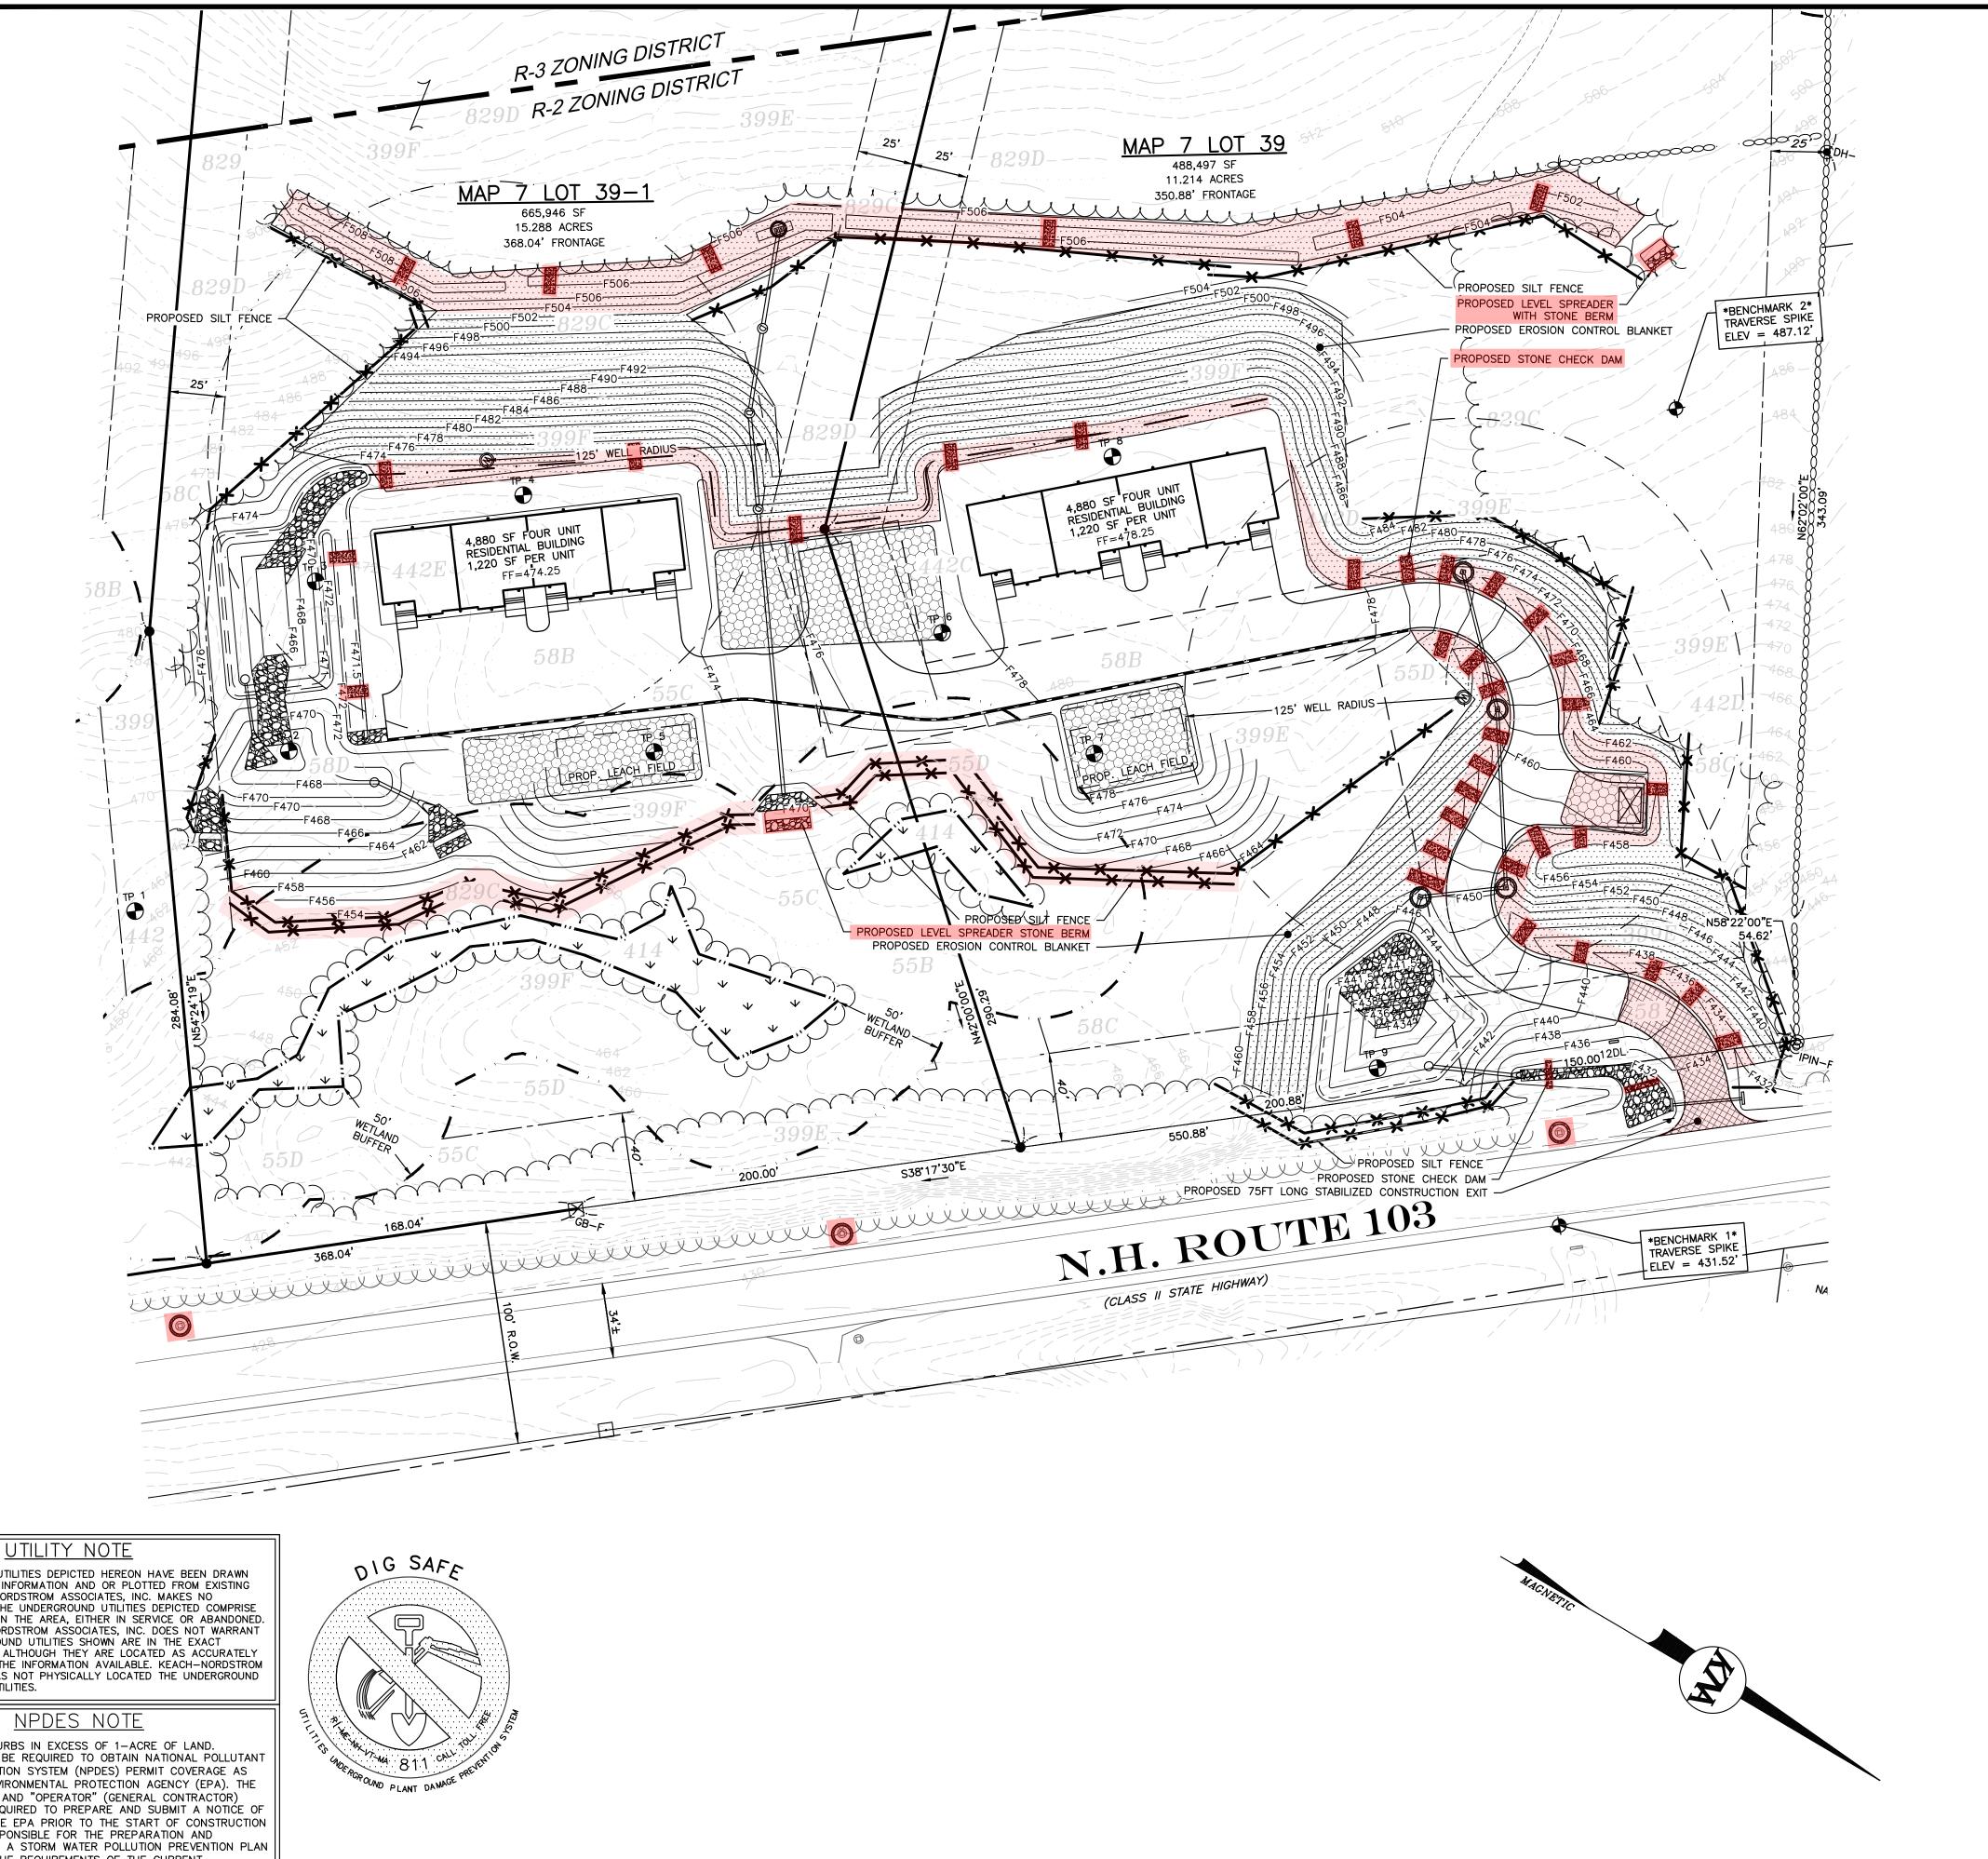

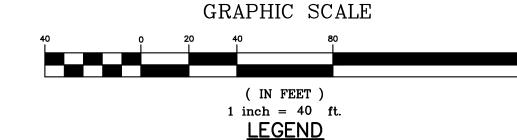

EDGE OF PAVEMENT IR−F IRON ROD FOUND ---- EDGE OF GRAVEL ⊚ RRSPK-F RAILROAD FOUND ———— 10' CONTOUR DRILL HOLE FOUND ---- 2' CONTOUR BENCHMARK STONEWALL UTILITY POLE • • • • • • • • • SOIL LINE SPOT LIGHT —— – —— SETBACK — - - — - — EASEMENT DOUBLE CATCH BASIN RIP-RAP FLARED END SECTION — —— ABUTTER LINE PROPERTY LINE = = = = = DRAINAGE LINE . TREELINE

> LOAM & SEED ALL DISTURBED AREAS (TYP.)

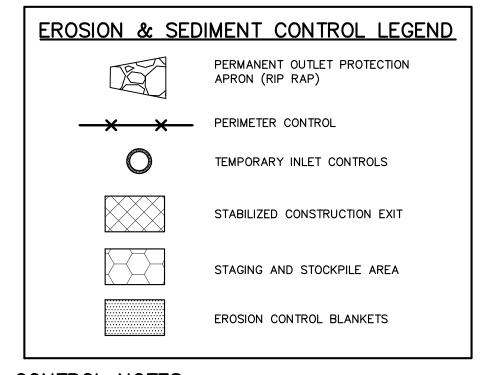

EROSION CONTROL NOTES:

- THE PURPOSE OF THIS PLAN IS TO DEPICT THE REQUIRED ONSITE TEMPORARY CONSTRUCTION EROSION CONTROL MEASURES AS WELL AS THE PERMANENT EROSION CONTROL MEASURES. 2. ALL MEASURES IN THE PLAN SHALL MEET AS A MINIMUM THE BEST MANAGEMENT PRACTICES SET FORTH IN VOLUME 3 OF THE NEW HAMPSHIRE STORMWATER MANUEL TITLED "EROSION AND SEDIMENT
- CONTROLS DURING CONSTRUCTION," DATED DECEMBER 2010, AS AMENDED FROM TIME TO TIME. 3. WHENEVER PRACTICAL, NATURAL VEGETATION SHALL BE RETAINED, PROTECTED OR SUPPLEMENTED. THE STRIPPING OF VEGETATION SHALL BE DONE IN A MANNER THAT MINIMIZES SOIL EROSION.
- 4. APPROPRIATE EROSION AND SEDIMENT CONTROL MEASURES SHALL BE INSTALLED PRIOR TO LAND DISTURBANCE USING WILDLIFE FRIENDLY EROSION CONTROL MATERIALS TO PREVENT TRAPPING OF 5. THE AREA OF DISTURBANCE SHALL BE KEPT TO A MINIMUM. DISTURBED AREAS REMAINING IDLE FOR
- MORE THAN 5 DAYS SHALL BE STABILIZED.
- 6. MEASURES SHALL BE TAKEN TO CONTROL EROSION WITHIN THE PROJECT AREA. SEDIMENT IN RUNOFF WATER SHALL BE TRAPPED AND RETAINED WITHIN THE PROJECT AREA USING APPROVED MEASURES. WETLAND AREAS AND SURFACE WATERS SHALL BE PROTECTED FROM SEDIMENT. 7. OFFSITE SURFACE WATER AND RUNOFF FROM UNDISTURBED AREAS SHALL BE DIVERTED AWAY FROM
- DISTURBED AREAS WHERE FEASIBLE OR CARRIED NON-EROSIVELY THROUGH THE PROJECT AREA. INTEGRITY OF DOWNSTREAM DRAINAGE SYSTEMS SHALL BE MAINTAINED.
- 8. ALL TEMPORARY EROSION AND SEDIMENT CONTROL MEASURES SHALL BE MAINTAINED IN FUNCTIONING CONDITION UNTIL FINAL SITE STABILIZATION IS ACCOMPLISHED.
- 9. ALL TEMPORARY EROSION AND SEDIMENT CONTROL MEASURES SHALL BE REMOVED AFTER FINAL SITE STABILIZATION. TRAPPED SEDIMENT AND OTHER DISTURBED SOIL AREAS RESULTING FROM THE REMOVAL OF TEMPORARY MEASURES SHALL BE PERMANENTLY STABILIZED WITHIN 5 DAYS UNLESS CONDITIONS DICTATE OTHERWISE. 10. THE TOWN OF WARNER SHALL RESERVE THE RIGHT TO REQUIRE FURTHER EROSION CONTROL PRACTICES
- DURING CONSTRUCTION SHOULD THEY FIND IT NECESSARY.

 11. SNOW ACCUMULATED DURING THE WINTER CONSTRUCTION CONDITIONS SHOULD BE STORED IN THE
- STAGING & STOCKPILE AREA DETERMINED BY THE CONTRACTOR, SURROUNDED BY SILT FENCE. 12. THE CONTRACTOR SHALL NOT DISCHARGE RUNOFF FROM UNSTABILIZED AREAS OF THE SITE TO
- 13. PERIODIC INSPECTION AND MAINTENANCE OF THE CULVERTS AND CATCH BASINS SHALL OCCUR. SEE OPERATIONS AND MAINTENANCE PLAN FOR DETAILS.

EROSION CONTROL PLAN

JENNESSTOWN MANOR MAP 7, LOTS 39 & 39-1

> ROUTE 103 WARNER, NEW HAMPSHIRE MERRIMACK COUNTY

> > OWNER/APPLICANT:

PEACOCK HILL ROAD, LLC 145 OLD TOWN ROAD WEARE, NH 03281 BK. 3829 PG. 2512



KEACH-NORDSTROM ASSOCIATES, INC.


Civil Engineering Land Surveying Landscape Architecture 10 Commerce Park North, Suite 3B, Bedford, NH 03110 Phone (603) 627-2881

REVISIONS					
No.	DATE	DESCRIPTION		BY	
1	5/22/25	PER PB AND AOT COMME	ENTS	AEW	
				_	
DATE	DATE: MARCH 25, 2025 SCALE: 1" = 40'				
PROJ	PROJECT NO: 24-0307-1 SHEET 6 OF 16				

THE UNDERGROUND UTILITIES DEPICTED HEREON HAVE BEEN DRAWN FROM FIELD SURVEY INFORMATION AND OR PLOTTED FROM EXISTING DRAWINGS. KEACH-NORDSTROM ASSOCIATES, INC. MAKES NO GUARANTEES THAT THE UNDERGROUND UTILITIES DEPICTED COMPRISE ALL SUCH UTILITIES IN THE AREA, EITHER IN SERVICE OR ABANDONED. FURTHER, KEACH-NORDSTROM ASSOCIATES, INC. DOES NOT WARRANT THAT THE UNDERGROUND UTILITIES SHOWN ARE IN THE EXACT LOCATION INDICATED ALTHOUGH THEY ARE LOCATED AS ACCURATELY AS POSSIBLE FROM THE INFORMATION AVAILABLE. KEACH-NORDSTROM ASSOCIATES, INC. HAS NOT PHYSICALLY LOCATED THE UNDERGROUND PORTIONS OF THE UTILITIES.

THIS PROJECT DISTURBS IN EXCESS OF 1-ACRE OF LAND. THEREFORE IT WILL BE REQUIRED TO OBTAIN NATIONAL POLLUTANT DISCHARGE ELIMINATION SYSTEM (NPDES) PERMIT COVERAGE AS ISSUED BY THE ENVIRONMENTAL PROTECTION AGENCY (EPA). THE OWNER/DEVELOPER AND "OPERATOR" (GENERAL CONTRACTOR) SHALL EACH BE REQUIRED TO PREPARE AND SUBMIT A NOTICE OF INTENT (NOI) TO THE EPA PRIOR TO THE START OF CONSTRUCTION AND SHALL BE RESPONSIBLE FOR THE PREPARATION AND IMPLEMENTATION OF A STORM WATER POLLUTION PREVENTION PLAN (SWPPP) MEETING THE REQUIREMENTS OF THE CURRENT

CONSTRUCTION GENERAL PERMIT.

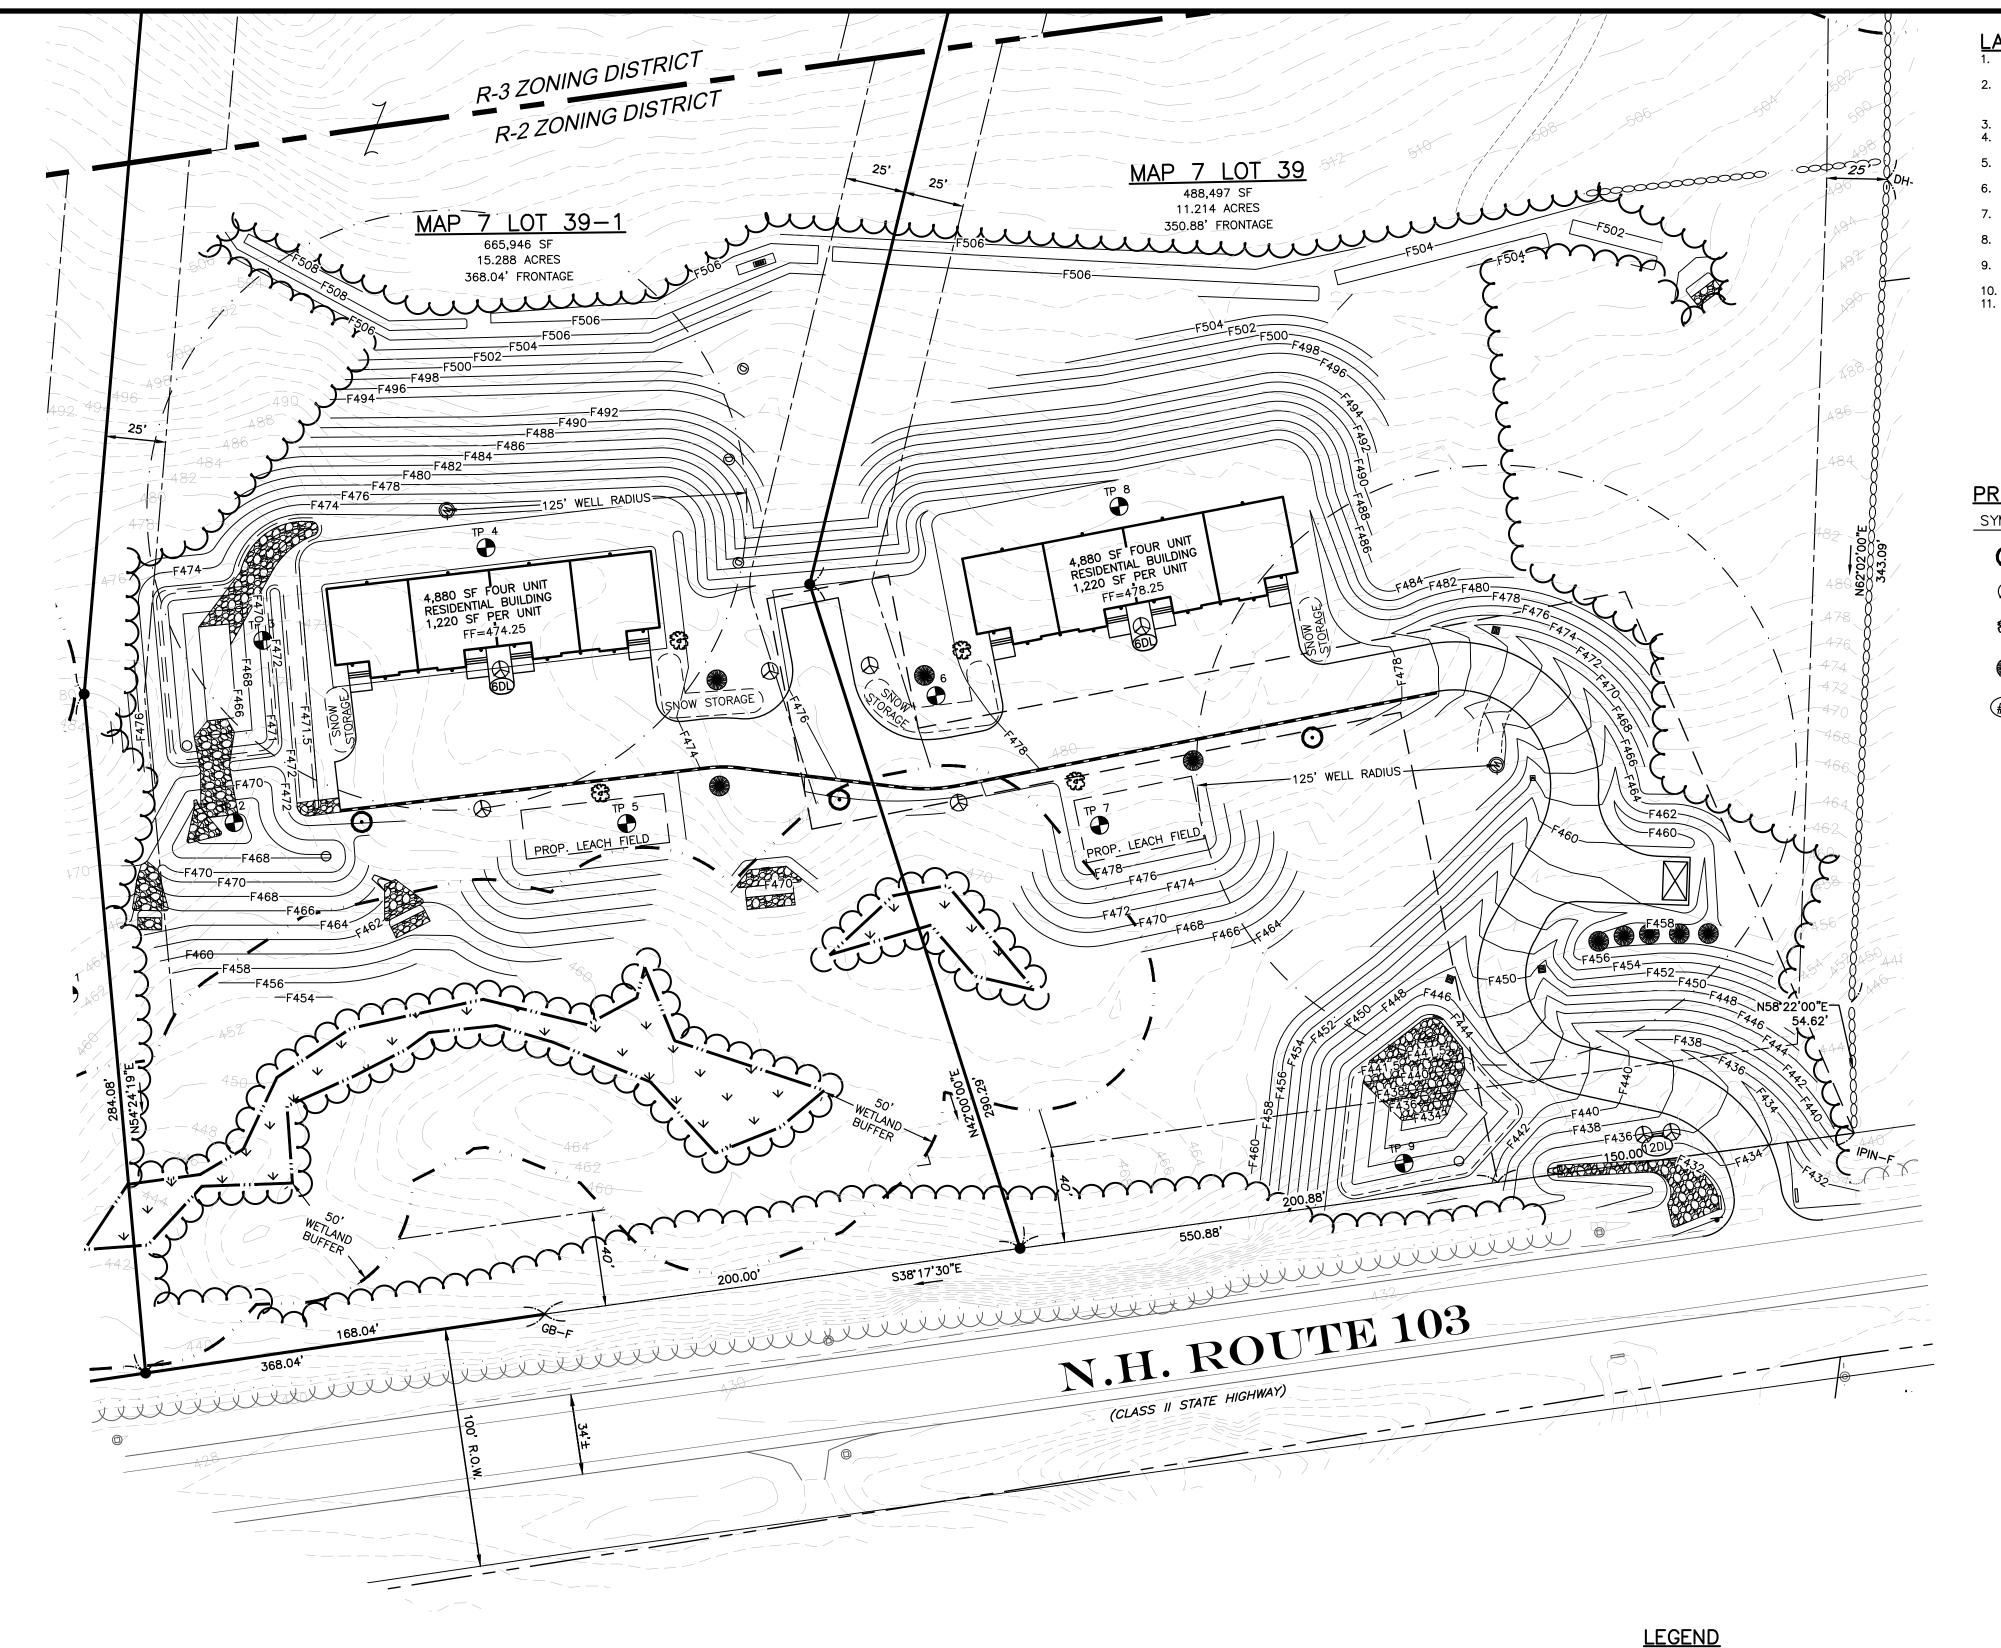

UTILITY NOTE

THE UNDERGROUND UTILITIES DEPICTED HEREON HAVE BEEN DRAWN FROM FIELD SURVEY INFORMATION AND OR PLOTTED FROM EXISTING DRAWINGS. KEACH-NORDSTROM ASSOCIATES, INC. MAKES NO GUARANTEES THAT THE UNDERGROUND UTILITIES DEPICTED COMPRISE ALL SUCH UTILITIES IN THE AREA, EITHER IN SERVICE OR ABANDONED. FURTHER, KEACH-NORDSTROM ASSOCIATES, INC. DOES NOT WARRANT THAT THE UNDERGROUND UTILITIES SHOWN ARE IN THE EXACT LOCATION INDICATED ALTHOUGH THEY ARE LOCATED AS ACCURATELY AS POSSIBLE FROM THE INFORMATION AVAILABLE. KEACH-NORDSTROM ASSOCIATES, INC. HAS NOT PHYSICALLY LOCATED THE UNDERGROUND PORTIONS OF THE UTILITIES.

NPDES NOTE

THIS PROJECT DISTURBS IN EXCESS OF 1-ACRE OF LAND. THEREFORE IT WILL BE REQUIRED TO OBTAIN NATIONAL POLLUTANT DISCHARGE ELIMINATION SYSTEM (NPDES) PERMIT COVERAGE AS ISSUED BY THE ENVIRONMENTAL PROTECTION AGENCY (EPA). THE OWNER/DEVELOPER AND "OPERATOR" (GENERAL CONTRACTOR) SHALL EACH BE REQUIRED TO PREPARE AND SUBMIT A NOTICE OF INTENT (NOI) TO THE EPA PRIOR TO THE START OF CONSTRUCTION AND SHALL BE RESPONSIBLE FOR THE PREPARATION AND IMPLEMENTATION OF A STORM WATER POLLUTION PREVENTION PLAN (SWPPP) MEETING THE REQUIREMENTS OF THE CURRENT CONSTRUCTION GENERAL PERMIT.



GRANITE BOUND FOUND STONE POST

STONE BOUND FOUND DRILL HOLE SET BENCHMARK UTILITY POLE CATCH BASIN PROPOSED CATCH BASIN PROPOSED OUTLET STRUCTURE PROPOSED END SECTION PROPOSED UTILITY POLE

in the contraction of the contraction and the contraction of the contr

. PROPOSED TREELINE

. TREELINE

---- EDGE OF GRAVEL

SETBACK EASEMENT WETLAND WETLAND BUFFER PROPOSED BITUMINOUS CURB ABUTTER LINE PROPERTY LINE

EDGE OF PAVEMENT


LANDSCAPE NOTES:

- AESTHETIC APPEAL.
 - 2. STRIPPED TOPSOIL SHALL BE STOCKPILED AND REUSED ON THE SITE WHERE NEEDED. TOPSOIL SHALL BE A MINIMUM OF 4 INCHES DEEP (MEASURED WHEN CONSOLIDATED). TOPSOIL SHALL BE TREATED IF NEEDED TO PROMOTE HEALTHY GRASS WHEN SEÈDED. SCARIFY AND REPEAT SEEDING AS NECESSARY.
- SITE PREPARATION IS TO BE CONDUCTED WITH MINIMAL DISTURBANCE TO EXISTING VEGETATION WHICH WILL REMAIN. 4. CONSTRUCTION MATERIALS, EQUIPMENT, VEHICLES OR TEMPORARY SOIL DEPOSITS SHALL NOT BE LOCATED WITHIN THE
- DRIP-LINE OF TREES THAT ARE TO BE PRESERVED. EXISTING TREES WHICH REMAIN SHALL BE PRUNED AND THINNED IF APPROPRIATE PER UNH COOPERATIVE EXTENSION
- RECOMMENDATIONS TO MAINTAIN HEALTHY APPEARANCES.
- 6. ALL OPEN SPACE AREAS NOT COVERED WITH PLANTINGS SHALL BE COVERED WITH GRASS OR OTHER VEGETATIVE
- GROUNDCOVERS, WITH THE EXCEPTION OF PLANTING BEDS WHICH MAY BE MULCHED.

 WHERE SLOPES OF 33% OR GREATER ARE CREATED OR DISTURBED, THEY SHALL BE COVERED OR PLANTED WITH DEEP
- ROOTED SPECIES TO PREVENT EROSION. 8. ALL DEAD, DYING, OR DISEASED VEGETATION SHALL BE PROMPTLY REPLACED, BASED ON SEASONAL PLANTING
- PRACTICES, WITH HEALTHY LIVING PLANTS IN ALL REQUIRED LANDSCAPE AREAS. 9. PROVIDE A MAINTENANCE ESCROW ACCOUNT TO ENSURE THAT ANY PLANTED MATERIALS WILL BE REPLACED IN THE
- EVENT THEY ARE DAMAGED OR DIE WITHIN ONE YEAR AFTER FINAL COMPLETION OF THE PROJECT.
- 10. NO PLANTINGS SHALL CONFLICT WITH SNOW STORAGE AREAS, LIGHT FIXTURES AND UNDERGROUND UTILITIES. 11. NO LANDSCAPING CONFLICTS WITH SIGHT DISTANCE.

PROJECT PLANT LIST

KOJE(<u>ا ۲ ا ر</u>	LAIVI LISI			MATURE	
YMBOL	QTY	BOTANICAL NAME	COMMON NAME	SIZE		<u>SPREA</u> D
0	3	ACER RUBRUM "REDPOINTE"	RED MAPLE	6'-7' B&B	30'-40'	30-40'
\otimes	8	SYRINGA PATULA "MISS KIM"	MISS KIM LILAC	2'-2.5' B&B	8 8'-10'	6'-8'
3	4	VIBURNUM DENTATUM	VIBURNUM "BLUE MUFFIN"	# 7	6'-8"	4'-5'
	9	RHODODENDRON PRINOPHYLLUM	EARLY AZALEA	#3	4'-8'	4'-8'
#DL)	24	HEMEROCALLIS HYBRIDS	DAYLILY	#2	2'-3'	3'

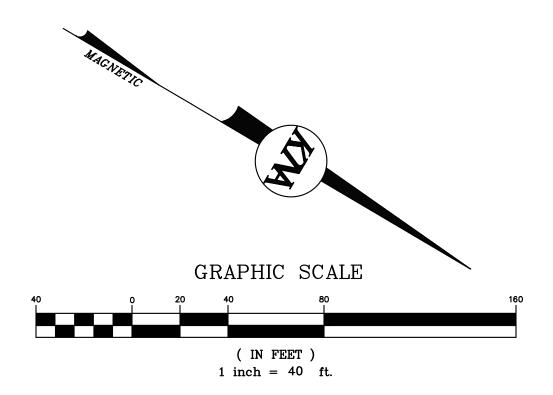

LANDSCAPE PLAN

JENNESSTOWN MANOR MAP 7, LOTS 39 & 39-1

ROUTE 103 WARNER, NEW HAMPSHIRE MERRIMACK COUNTY


OWNER/APPLICANT:

PEACOCK HILL ROAD, LLC 145 OLD TOWN ROAD WEARE, NH 03281 BK. 3829 PG. 2512



KEACH-NORDSTROM ASSOCIATES, INC.

٦	REVISIONS					
ı	No.	DATE	DESC	DESCRIPTION		
ı	1	5/22/25	PER PB AND AO	T COMMENTS	AEW	
	DATE: MARCH 25, 2025 SCALE: 1" = 40'					
	PROJECT NO: 24-0307-1 SHEET 7 OF 16			·		

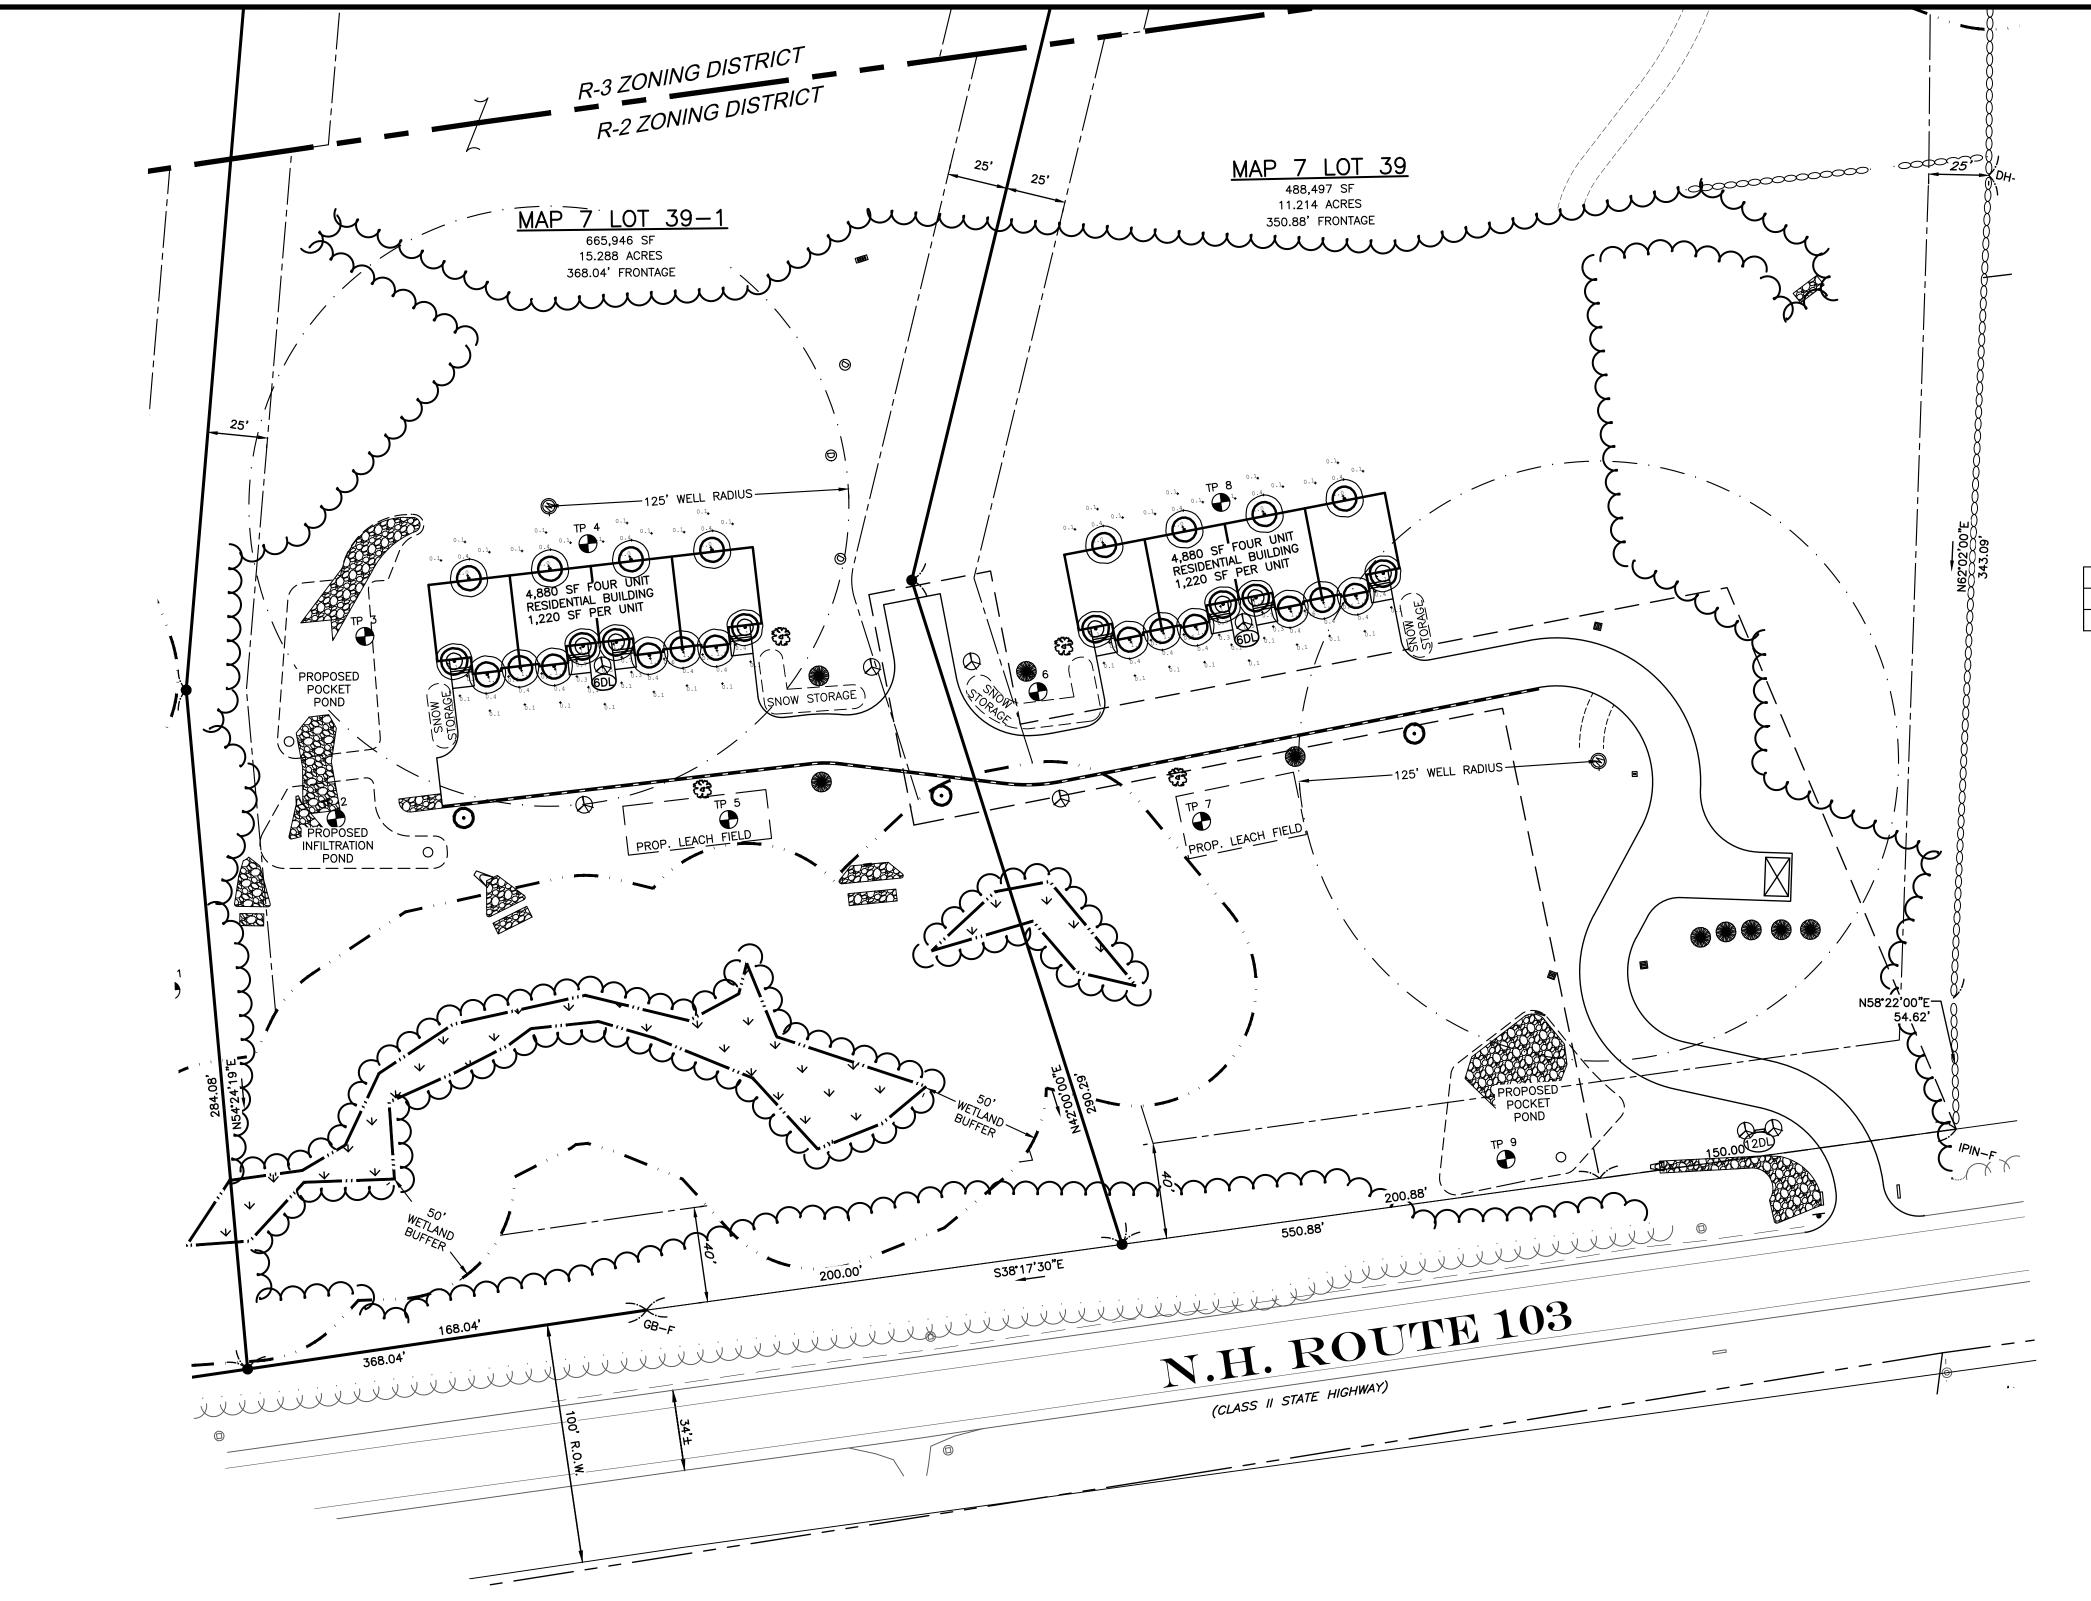

UTILITY NOTE

THE UNDERGROUND UTILITIES DEPICTED HEREON HAVE BEEN DRAWN FROM FIELD SURVEY INFORMATION AND OR PLOTTED FROM EXISTING DRAWINGS. KEACH-NORDSTROM ASSOCIATES, INC. MAKES NO GUARANTEES THAT THE UNDERGROUND UTILITIES DEPICTED COMPRISE ALL SUCH UTILITIES IN THE AREA, EITHER IN SERVICE OR ABANDONED. FURTHER, KEACH-NORDSTROM ASSOCIATES, INC. DOES NOT WARRANT THAT THE UNDERGROUND UTILITIES SHOWN ARE IN THE EXACT LOCATION INDICATED ALTHOUGH THEY ARE LOCATED AS ACCURATELY AS POSSIBLE FROM THE INFORMATION AVAILABLE. KEACH-NORDSTROM ASSOCIATES, INC. HAS NOT PHYSICALLY LOCATED THE UNDERGROUND PORTIONS OF THE UTILITIES.

NPDES NOTE

THIS PROJECT DISTURBS IN EXCESS OF 1-ACRE OF LAND. THEREFORE IT WILL BE REQUIRED TO OBTAIN NATIONAL POLLUTANT DISCHARGE ELIMINATION SYSTEM (NPDES) PERMIT COVERAGE AS ISSUED BY THE ENVIRONMENTAL PROTECTION AGENCY (EPA). THE OWNER/DEVELOPER AND "OPERATOR" (GENERAL CONTRACTOR) SHALL EACH BE REQUIRED TO PREPARE AND SUBMIT A NOTICE OF INTENT (NOI) TO THE EPA PRIOR TO THE START OF CONSTRUCTION AND SHALL BE RESPONSIBLE FOR THE PREPARATION AND IMPLEMENTATION OF A STORM WATER POLLUTION PREVENTION PLAN (SWPPP) MEETING THE REQUIREMENTS OF THE CURRENT CONSTRUCTION GENERAL PERMIT.



LEGEND

STONE POST STONE BOUND FOUND DRILL HOLE SET **BENCHMARK** UTILITY POLE CATCH BASIN PROPOSED CATCH BASIN PROPOSED OUTLET STRUCTURE PROPOSED END SECTION PROPOSED UTILITY POLE

THE THE PARTY OF T

GRANITE BOUND FOUND

EDGE OF PAVEMENT ---- EDGE OF GRAVEL EASEMENT

WETLAND ——— — ABUTTER LINE

. TREELINE

--- WETLAND BUFFER . PROPOSED TREELINE PROPOSED BITUMINOUS CURB

PROPERTY LINE

LIGHTING NOTES:

- EXTERIOR LIGHTING SHALL BE DESIGNED TO COORDINATE WITH THE BUILDING ARCHITECTURE AND LANDSCAPING, AND SHOULD CONTRIBUTE TO THE CHARACTER OF THE PROPERTY, NEIGHBORHOOD, AND STREET.
- THE STYLE OF LIGHTING FIXTURES USED SHALL BE UNIFORM FOR THE ENTIRE SITE. OUTDOOR LIGHTING IS RESTRICTED TO THAT WHICH IS NECESSARY FOR SAFETY AND SECURITY OF THE DEVELOPMENT.
 WHERE PRACTICAL, EXTERIOR LIGHTING INSTALLATIONS SHALL INCLUDE TIMERS, DIMMERS, MOTION SENSORS, OR
- 5. EXTERIOR LIGHTING INSTALLATIONS SHALL BE DESIGNED TO AVOID HARSH CONTRASTS IN LIGHTING LEVELS. CONTROL OF GLARE
- 6. THE PURPOSE OF THIS PLAN IS TO SHOW THE PROPOSED SITE LIGHTING. LIGHTING SHALL BE POSITIONED TO PREVENT UNDESIRABLE INCIDENTAL ILLUMINATION OF ABUTTING PROPERTIES, THE

- 8. SECURITY, [PARKING LOT, AND SIGN LIGHTING SHALL BE SHIELDED OR OTHERWISE DESIGN THE ENSURE THE LIGHT IS
- 9. TO PREVENT LIGHT POLLUTION AND IMPACTS ON ABUTTING PROPERTIES, THE TOTAL CUTOFF OF LIGHT SHOULD OCCUR WITHIN THE PROPERTY LINES OF THE LOT TO BE DEVELOPED.


PHOTOCELL CONTROLLERS THAT TURN THE LIGHTS OFF DURING DAYLIGHT HOURS OR HOURS WHEN LIGHTING IS NOT

Luminaire Schedule Description [MANUFAC] Qty Label Arrangement 28 Single 47356-016 EUROFASE



DECKARD, 12IN INTEGRATED LED OUTDOOR WALL LANTERN

NOT TO SCALE

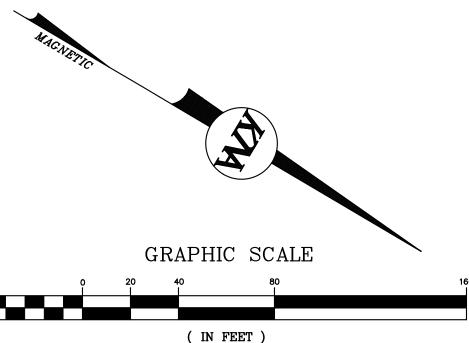

1 inch = 40 ft.

JENNESSTOWN MANOR MAP 7, LOTS 39 & 39-1

LIGHTING PLAN

ROUTE 103 WARNER, NEW HAMPSHIRE MERRIMACK COUNTY


OWNER/APPLICANT:


PEACOCK HILL ROAD, LLC 145 OLD TOWN ROAD WEARE, NH 03281 BK. 3829 PG. 2512




KEACH-NORDSTROM ASSOCIATES, INC.

٦	REVISIONS					
ı	No.	DATE	DESC	DESCRIPTION BY		
	1	5/22/25	PER PB AND AO	T COMMENTS	AEW	
	DATE: MARCH 25, 2025 SCALE: 1" = 40'					
	PROJECT NO: 24-0307-1 SHEET 8 OF 16					

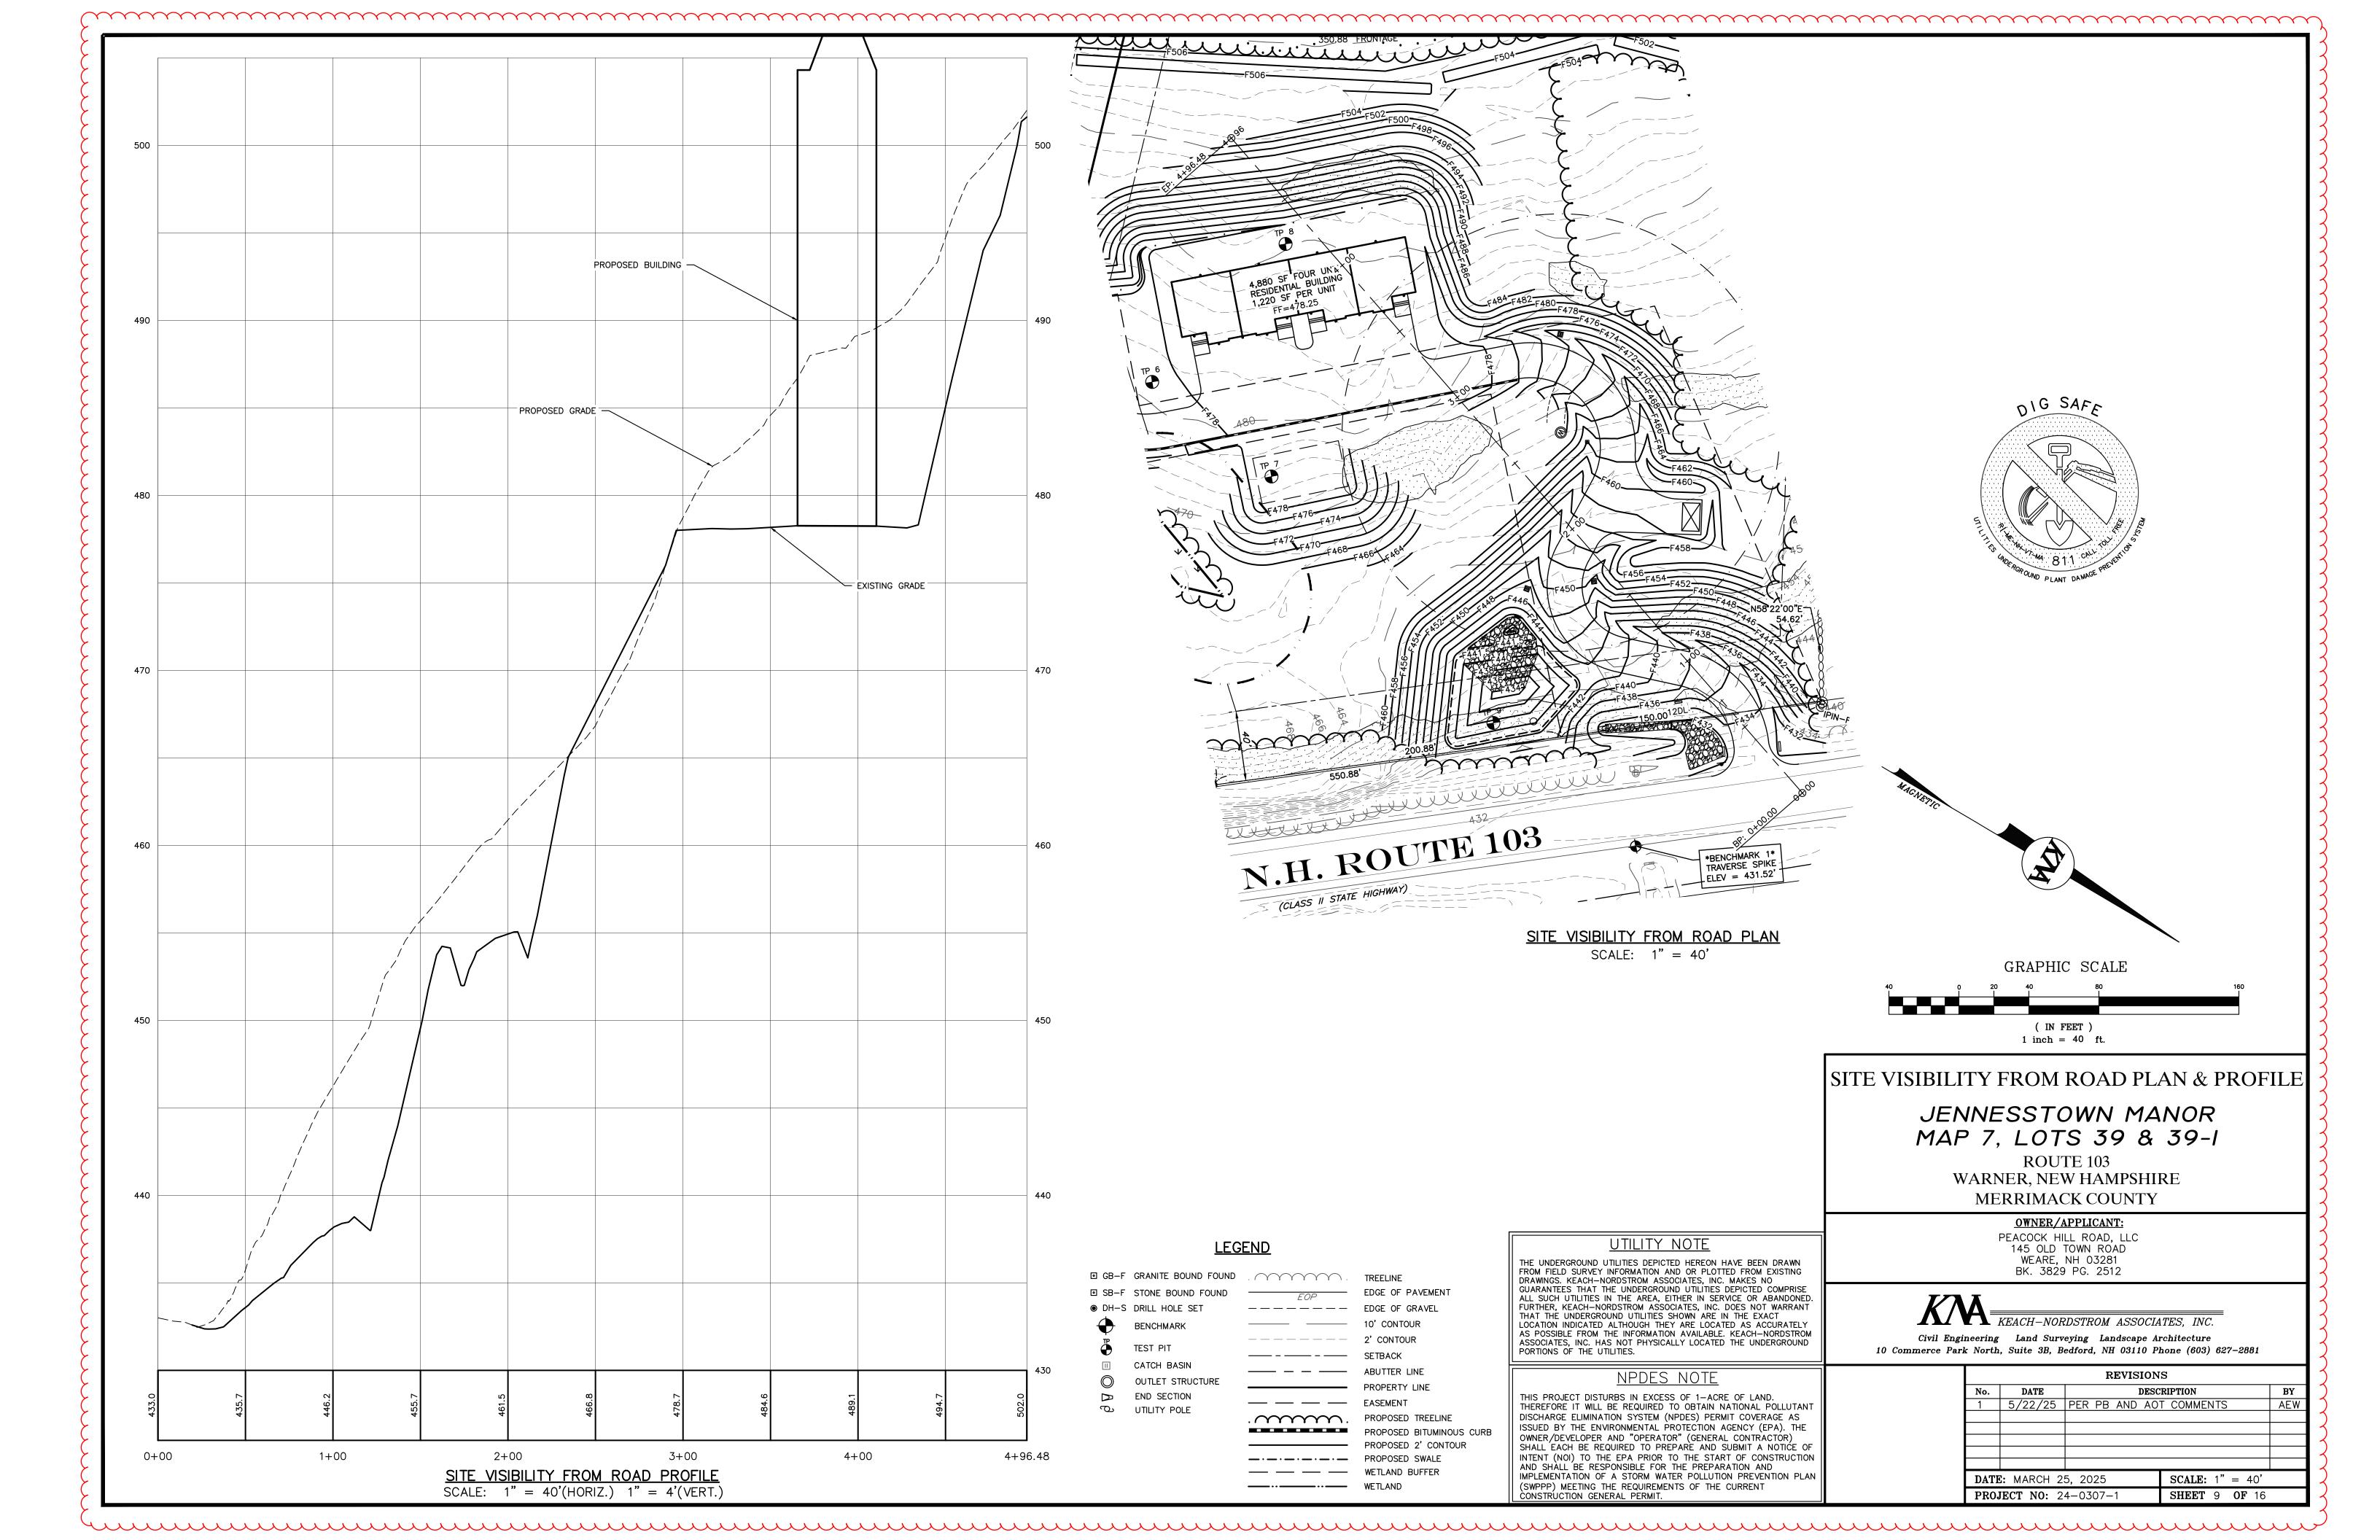

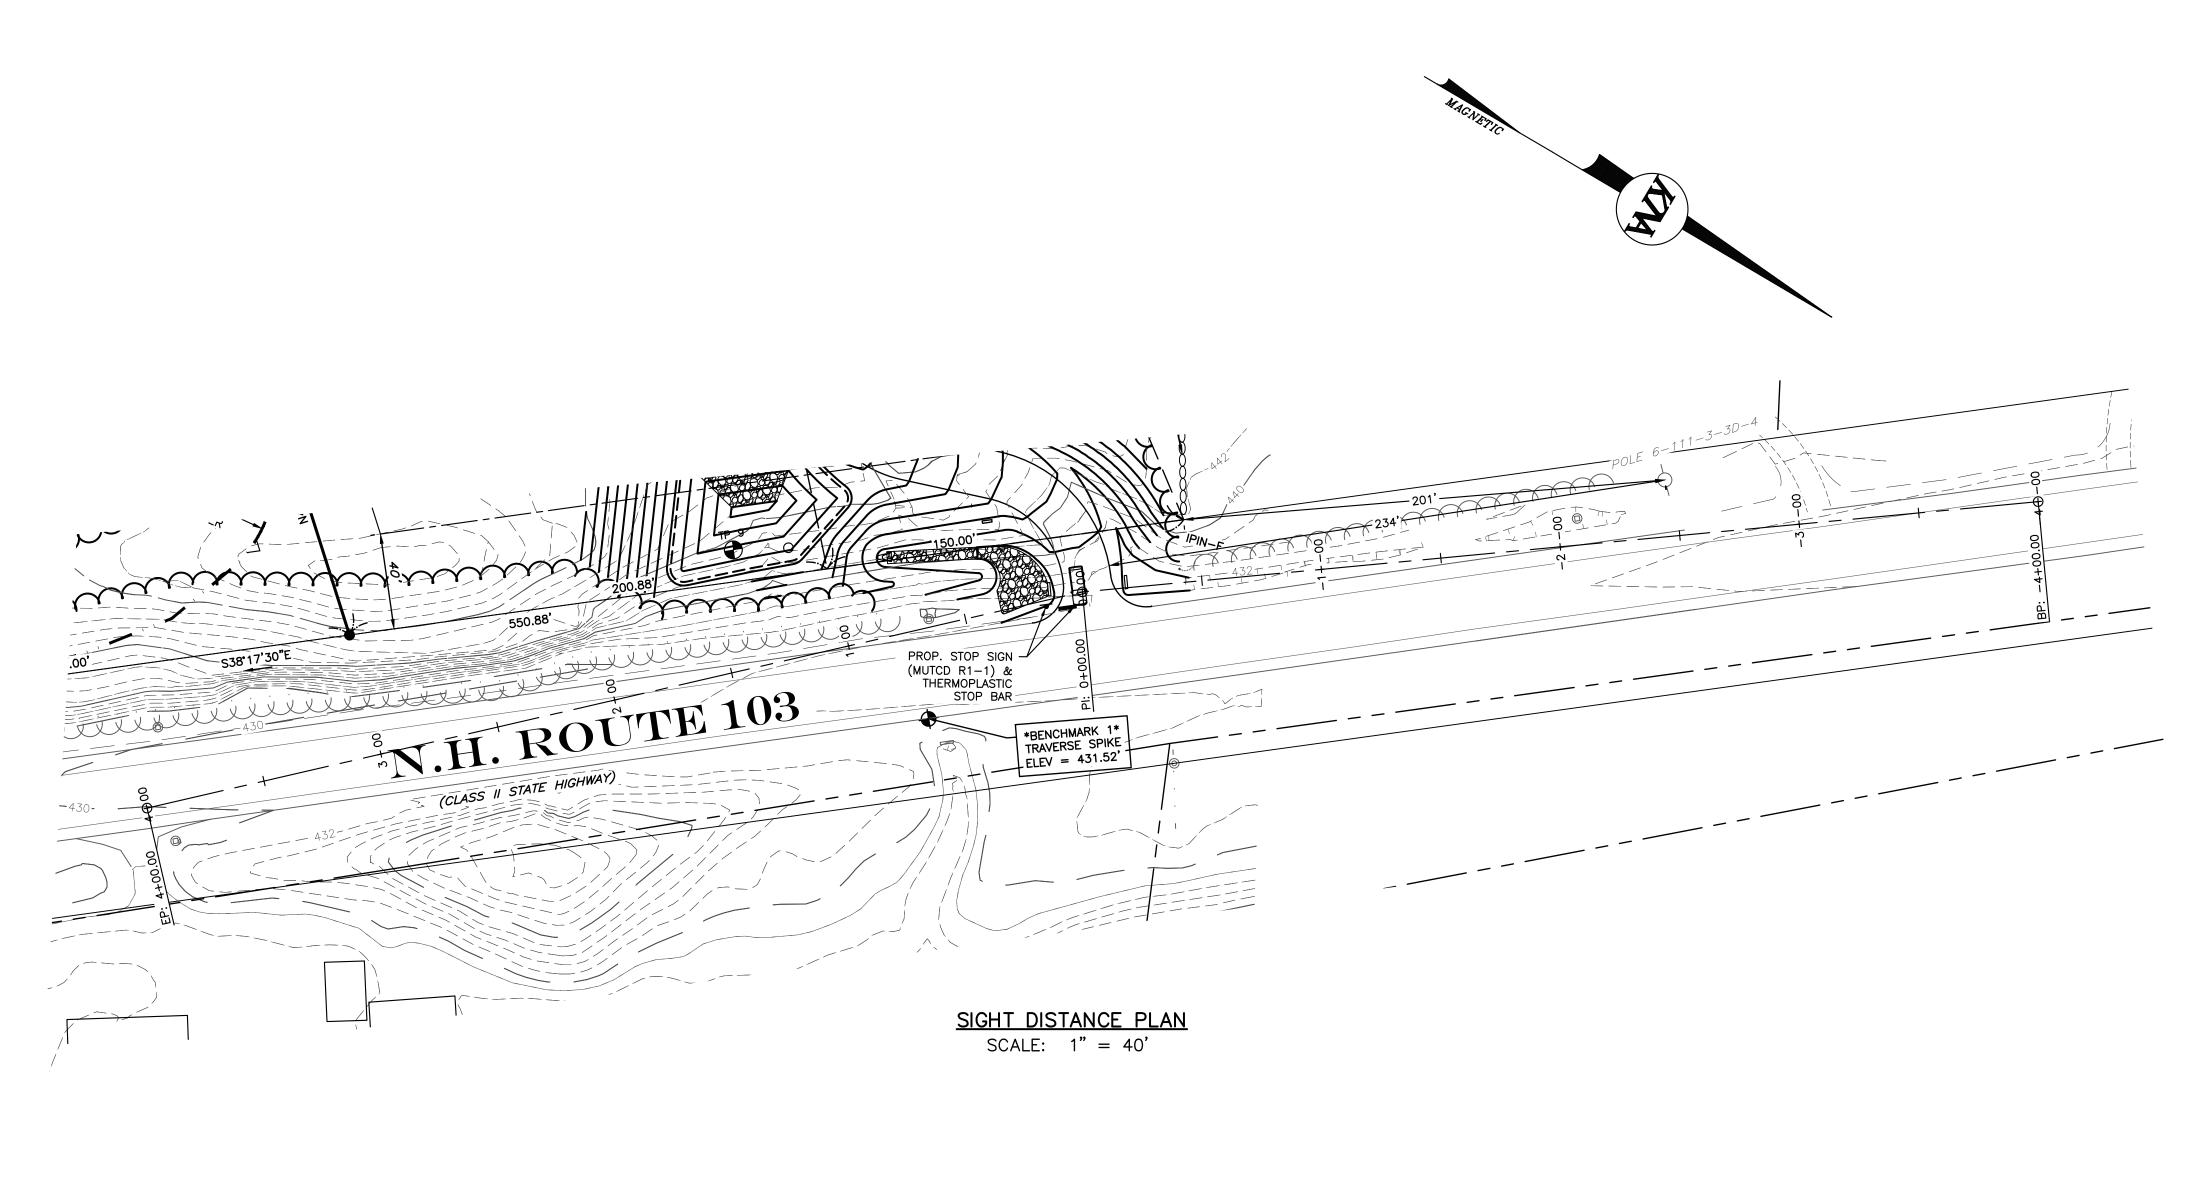

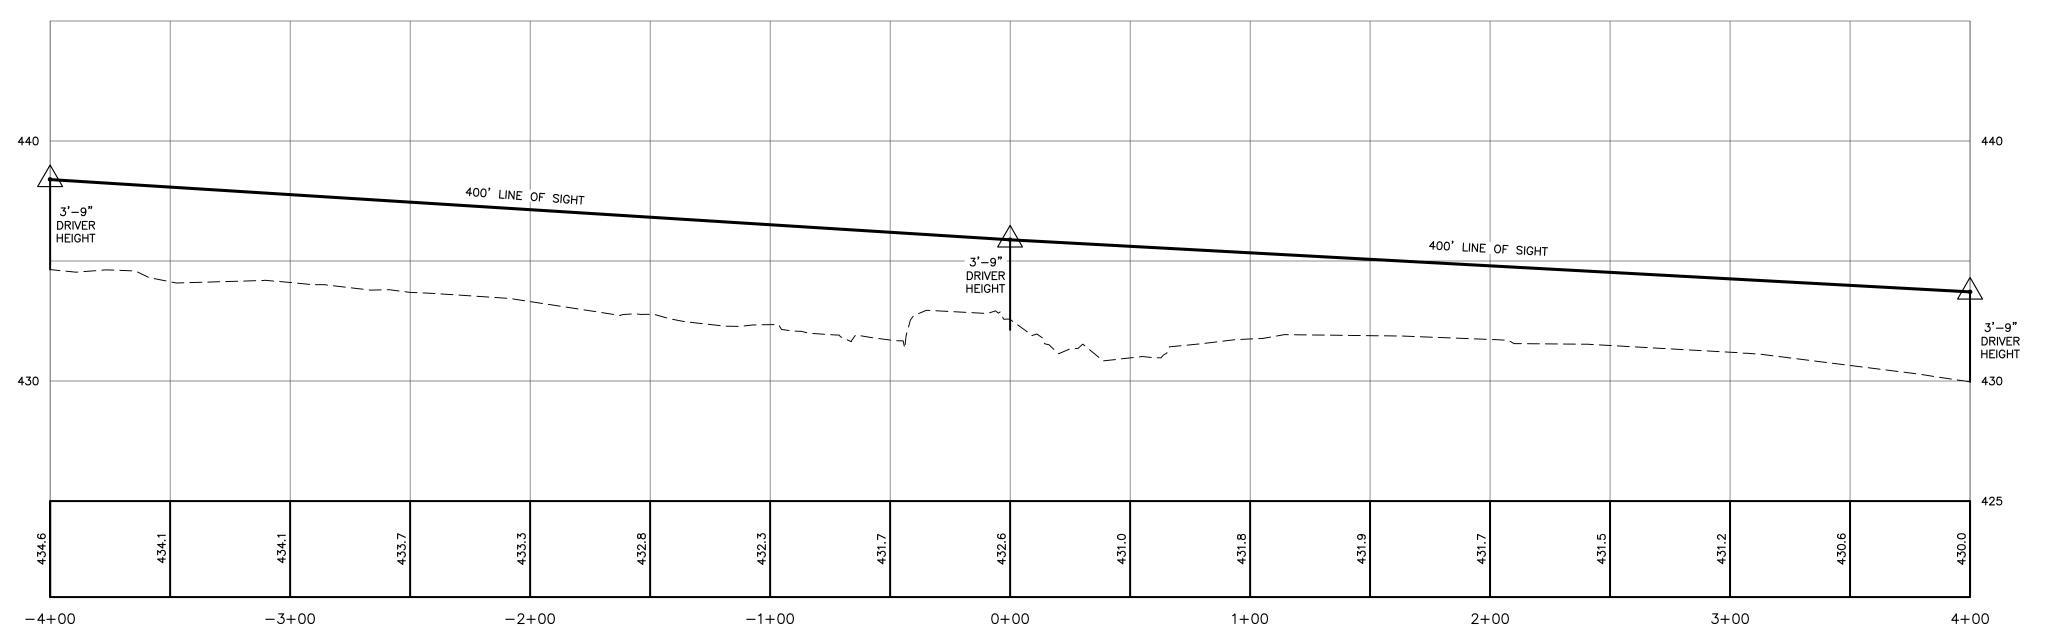

SIGHT DISTANCE PROFILE


SCALE: 1" = 40'(HORIZ.)

1" = 4'(VERT.)

NOTES:

1. THE PURPOSE OF THIS PLAN IS TO DEPICT THE SIGHT DISTANCE FOR MAP 7 LOT 39 IN WARNER, NEW HAMPSHIRE.

- 2. THE POSTED SPEED LIMIT ON ROUTE 103 IS 50 MPH.
- 3. ALL WORK PERFORMED WITHIN THE STATE R.O.W. SHALL BE IN ACCORDANCE WITH THE LATEST EDITION OF THE NHDOT STANDARD SPECIFICATIONS AND DETAILS.
- 4. LANDOWNER SHALL REMOVE VEGETATION AND OBSTRUCTIONS AS NEEDED TO MAINTAIN ALL SEASON SIGHT DISTANCE.

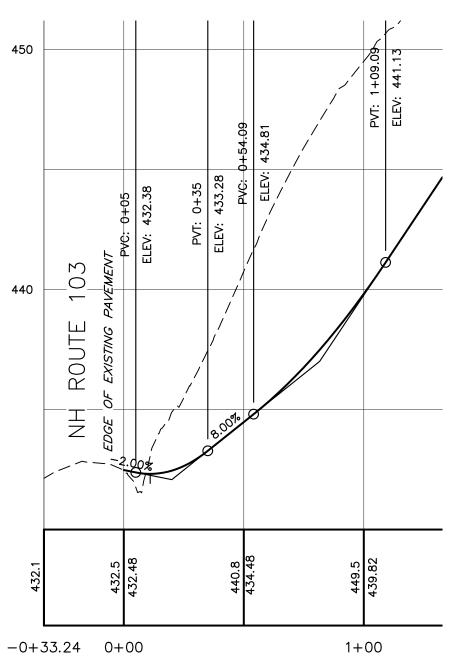

DRIVEWAY PROFILE SCALE: 1" = 40'(HORIZ.)1" = 4'(VERT.)

GRAPHIC SCALE (IN FEET)

1 inch = 40 ft.



UTILITY NOTE

THE UNDERGROUND UTILITIES DEPICTED HEREON HAVE BEEN DRAWN FROM FIELD SURVEY INFORMATION AND OR PLOTTED FROM EXISTING DRAWINGS. KEACH—NORDSTROM ASSOCIATES, INC. MAKES NO GUARANTEES THAT THE UNDERGROUND UTILITIES DEPICTED COMPRISE ALL SUCH UTILITIES IN THE AREA, EITHER IN SERVICE OR ABANDONED. FURTHER, KEACH—NORDSTROM ASSOCIATES, INC. DOES NOT WARRANT THAT THE UNDERGROUND UTILITIES SHOWN ARE IN THE EXACT LOCATION INDICATED ALTHOUGH THEY ARE LOCATED AS ACCURATELY AS POSSIBLE FROM THE INFORMATION AVAILABLE. KEACH—NORDSTROM ASSOCIATES, INC. HAS NOT PHYSICALLY LOCATED THE UNDERGROUND PORTIONS OF THE UTILITIES.

SITE DISTANCE PLAN

JENNESSTOWN MANOR MAP 7, LOTS 39 & 39-1


ROUTE 103 WARNER, NEW HAMPSHIRE MERRIMACK COUNTY

OWNER/APPLICANT:

PEACOCK HILL ROAD, LLC 145 OLD TOWN ROAD WEARE, NH 03281 BK. 3829 PG. 2512




T	REVISIONS					
	No.	DATE	DESC	DESCRIPTION BY		
	1	5/22/25	PER PB AND AO	T COMMENTS	AEW	
L						
⊢						
⊢						
<u> </u>						
L	DATE: MARCH 25, 2025 SCALE: 1" = 40'					
	PROJECT NO: 24-0307-1 SHE			SHEET 10 OF 16		

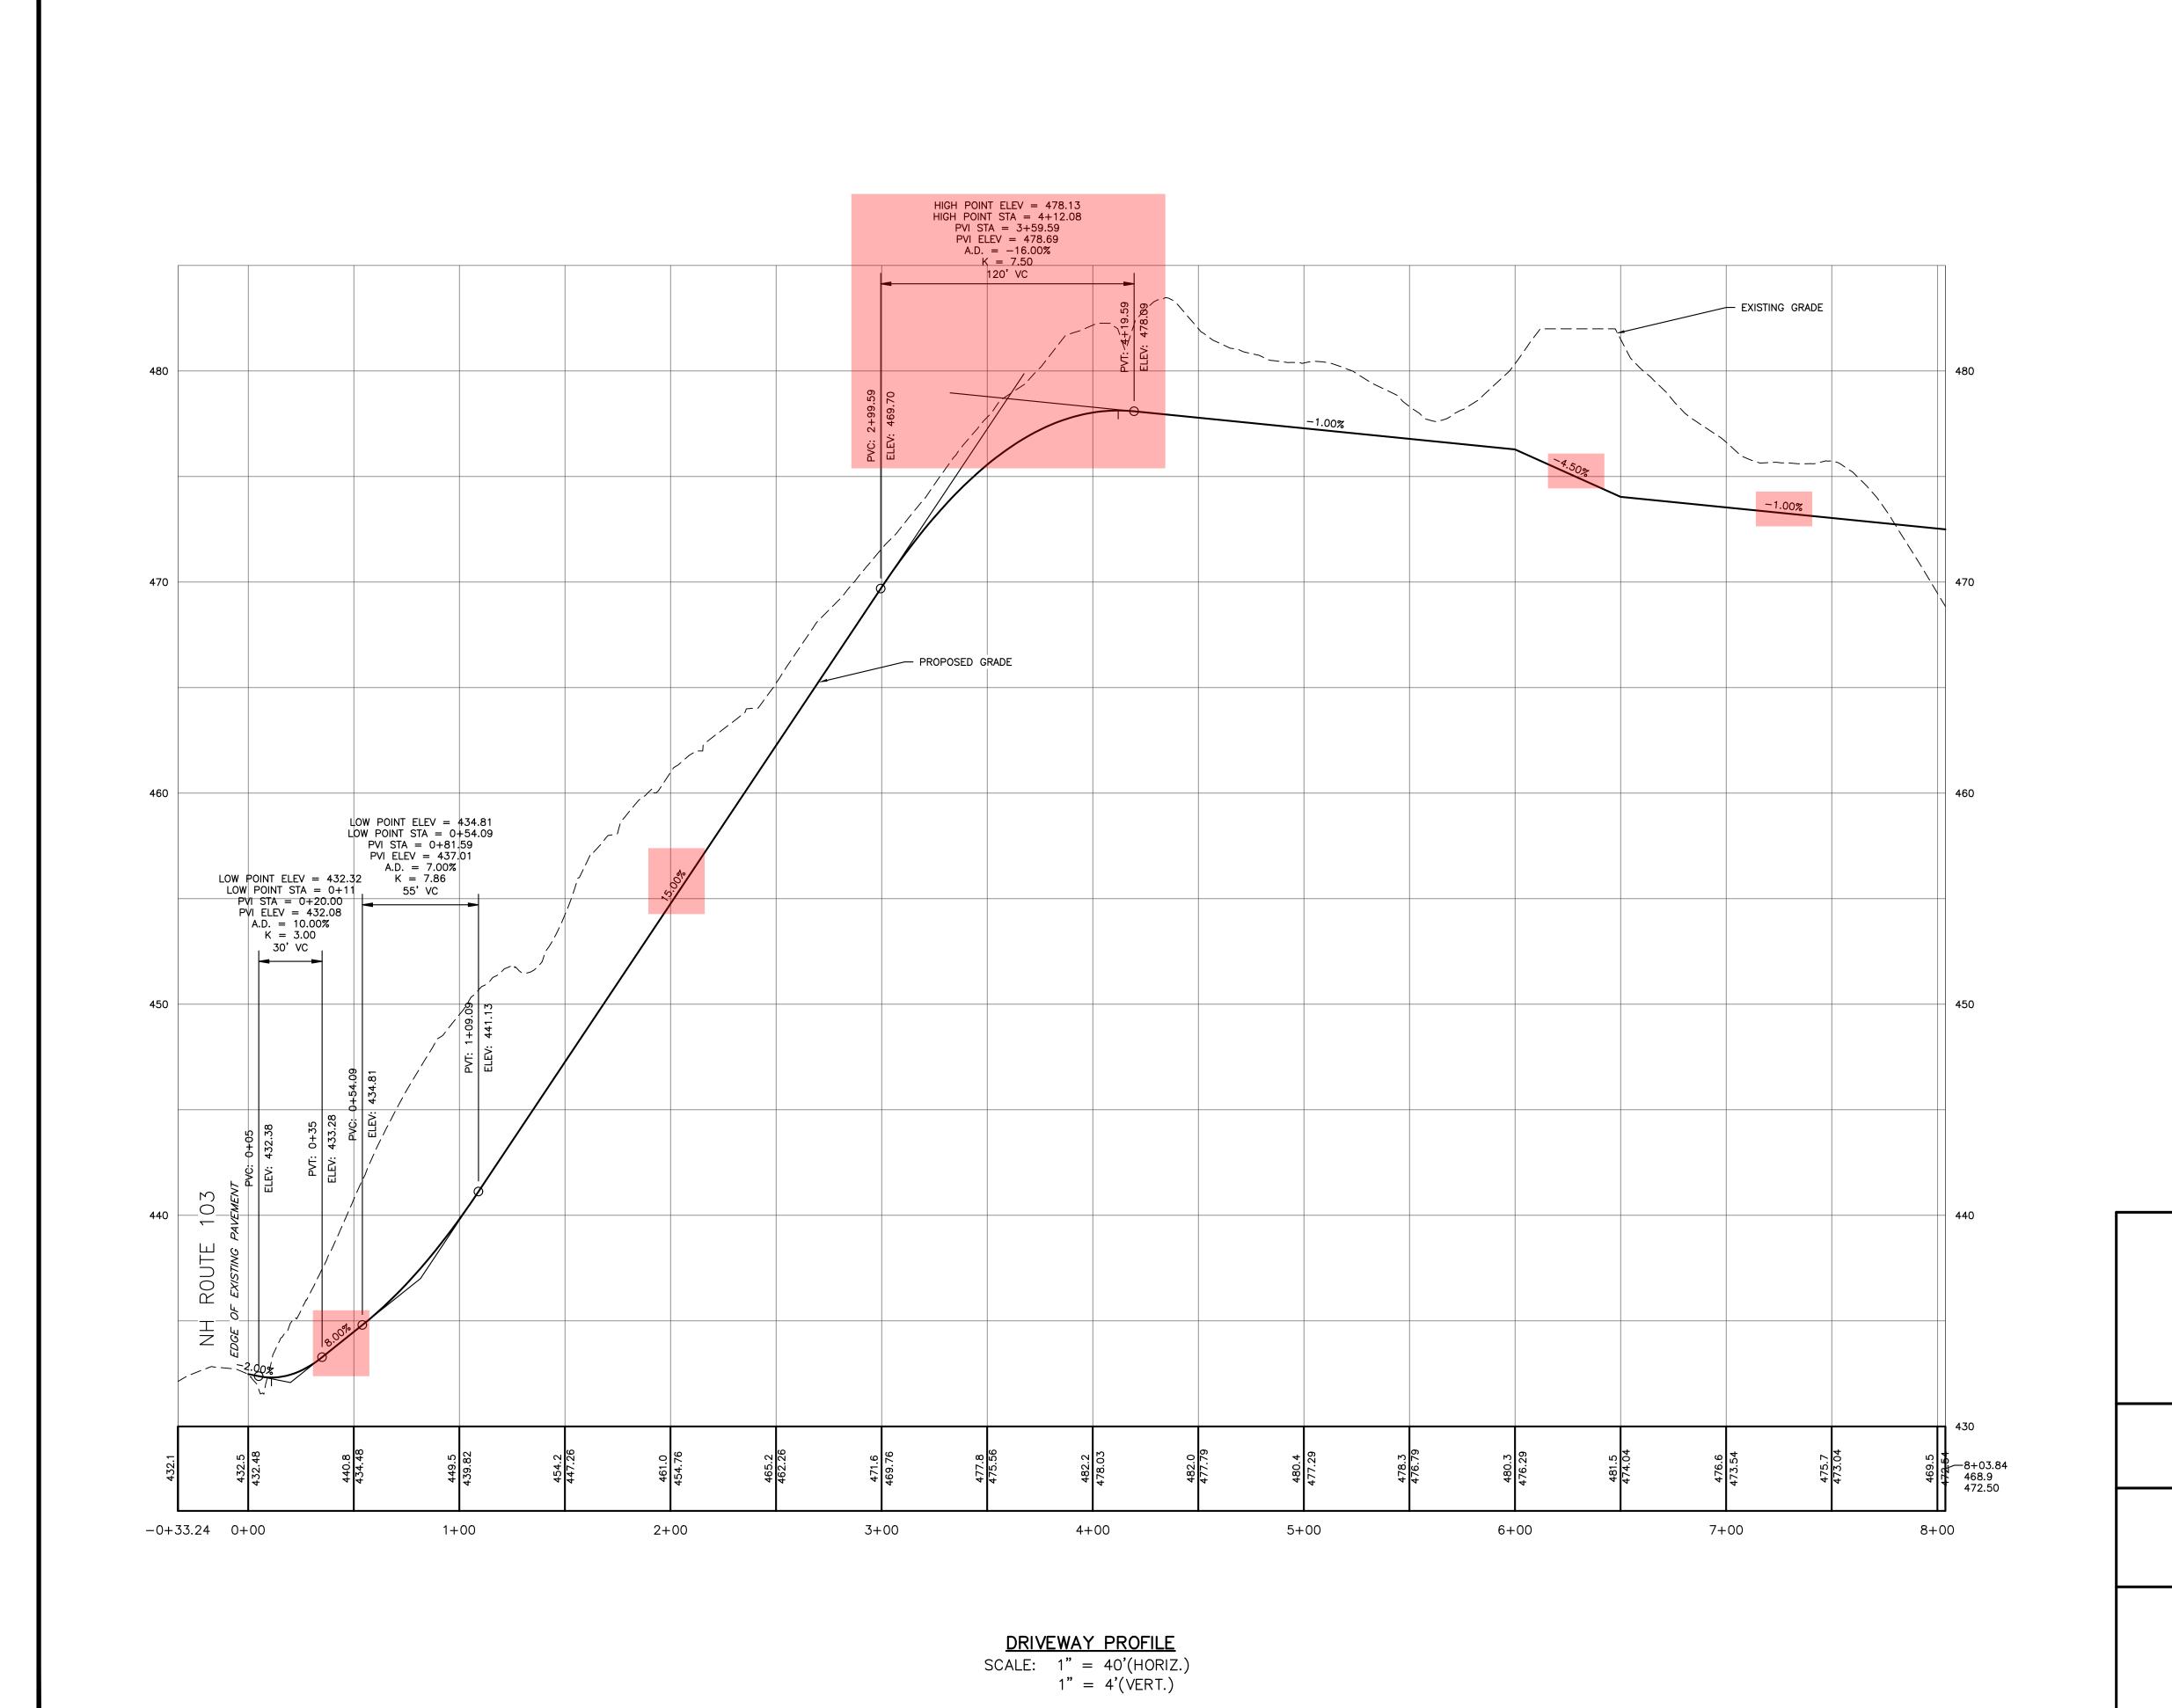



UTILITY NOTE

THE UNDERGROUND UTILITIES DEPICTED HEREON HAVE BEEN DRAWN FROM FIELD SURVEY INFORMATION AND OR PLOTTED FROM EXISTING DRAWINGS. KEACH—NORDSTROM ASSOCIATES, INC. MAKES NO GUARANTEES THAT THE UNDERGROUND UTILITIES DEPICTED COMPRISE ALL SUCH UTILITIES IN THE AREA, EITHER IN SERVICE OR ABANDONED. FURTHER, KEACH—NORDSTROM ASSOCIATES, INC. DOES NOT WARRANT THAT THE UNDERGROUND UTILITIES SHOWN ARE IN THE EXACT LOCATION INDICATED ALTHOUGH THEY ARE LOCATED AS ACCURATELY AS POSSIBLE FROM THE INFORMATION AVAILABLE. KEACH—NORDSTROM ASSOCIATES, INC. HAS NOT PHYSICALLY LOCATED THE UNDERGROUND PORTIONS OF THE UTILITIES.

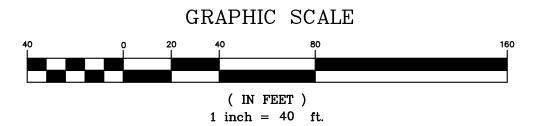

DRIVEWAY PROFILE PLAN

JENNESSTOWN MANOR MAP 7, LOTS 39 & 39-1

ROUTE 103 WARNER, NEW HAMPSHIRE MERRIMACK COUNTY


OWNER/APPLICANT:


PEACOCK HILL ROAD, LLC 145 OLD TOWN ROAD WEARE, NH 03281 BK. 3829 PG. 2512




KEACH-NORDSTROM ASSOCIATES, INC.

REVISIONS					
No. DATE DESCRIPTION			BY		
1	5/22/25	PER PB AND AC	T COMMENTS	AEW	
DATE: MARCH 25, 2025 SCALE: 1" = 40'					
PROJECT NO: 24-0307-1 SHEET 11 OF 16				•	

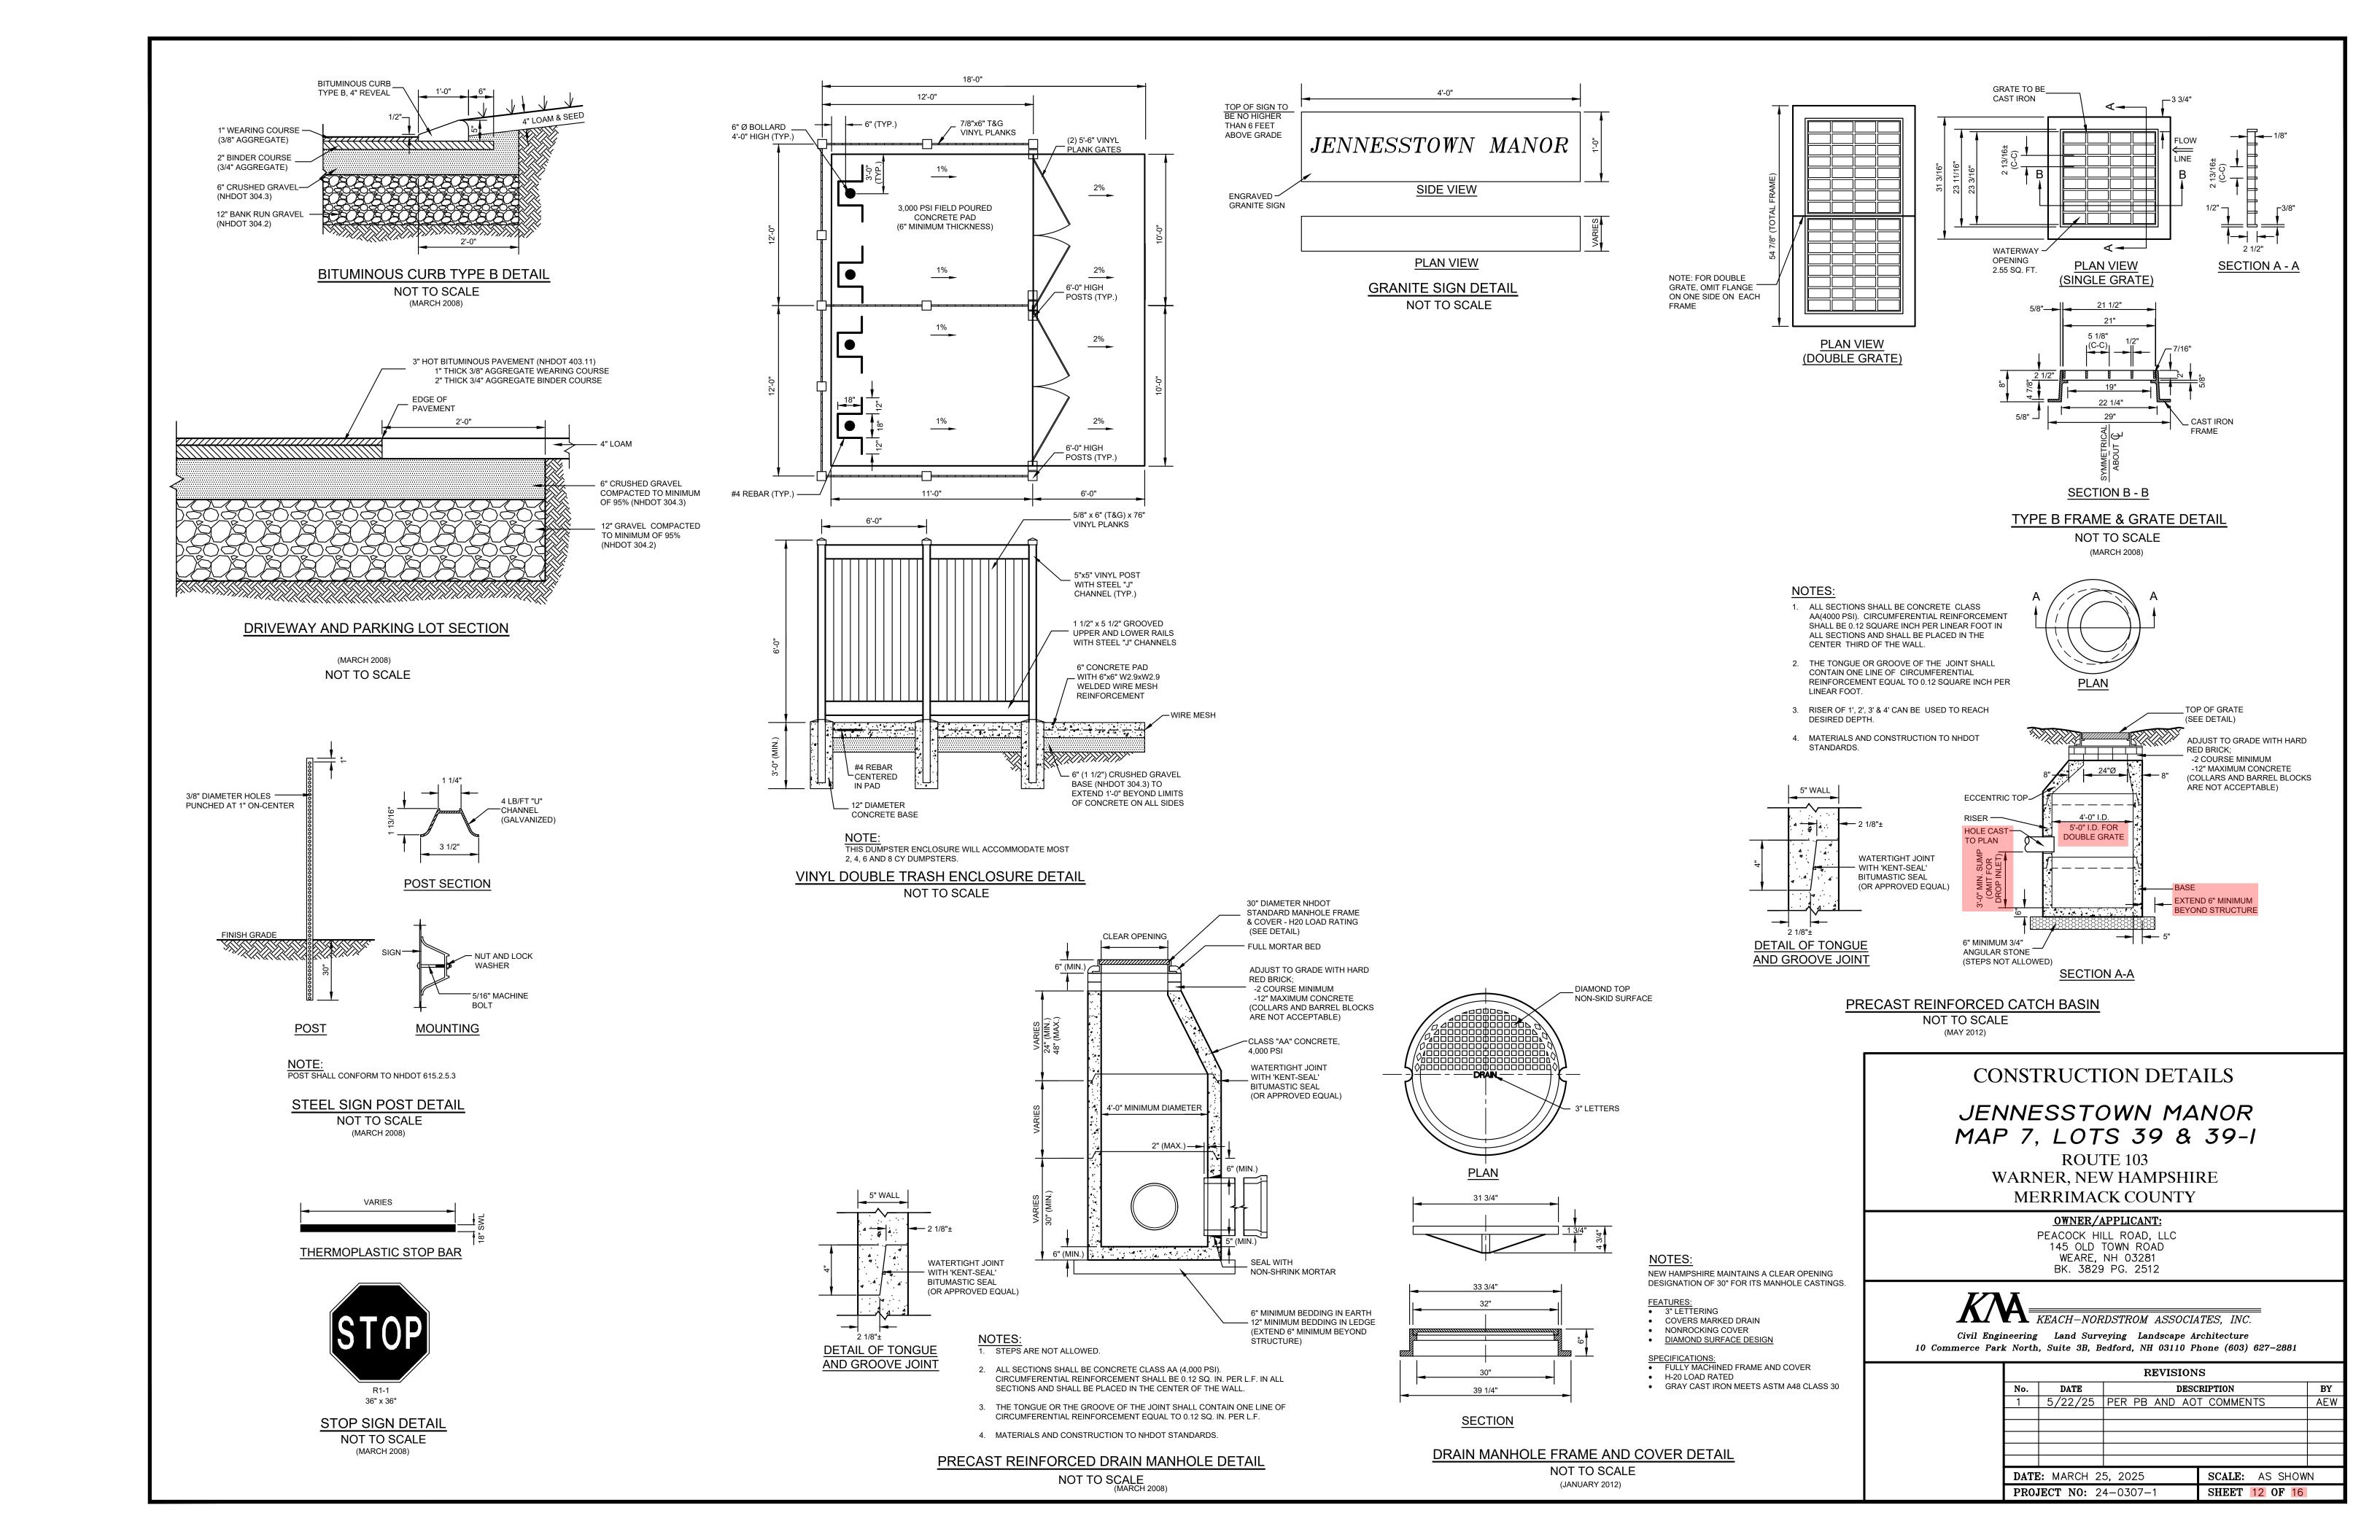

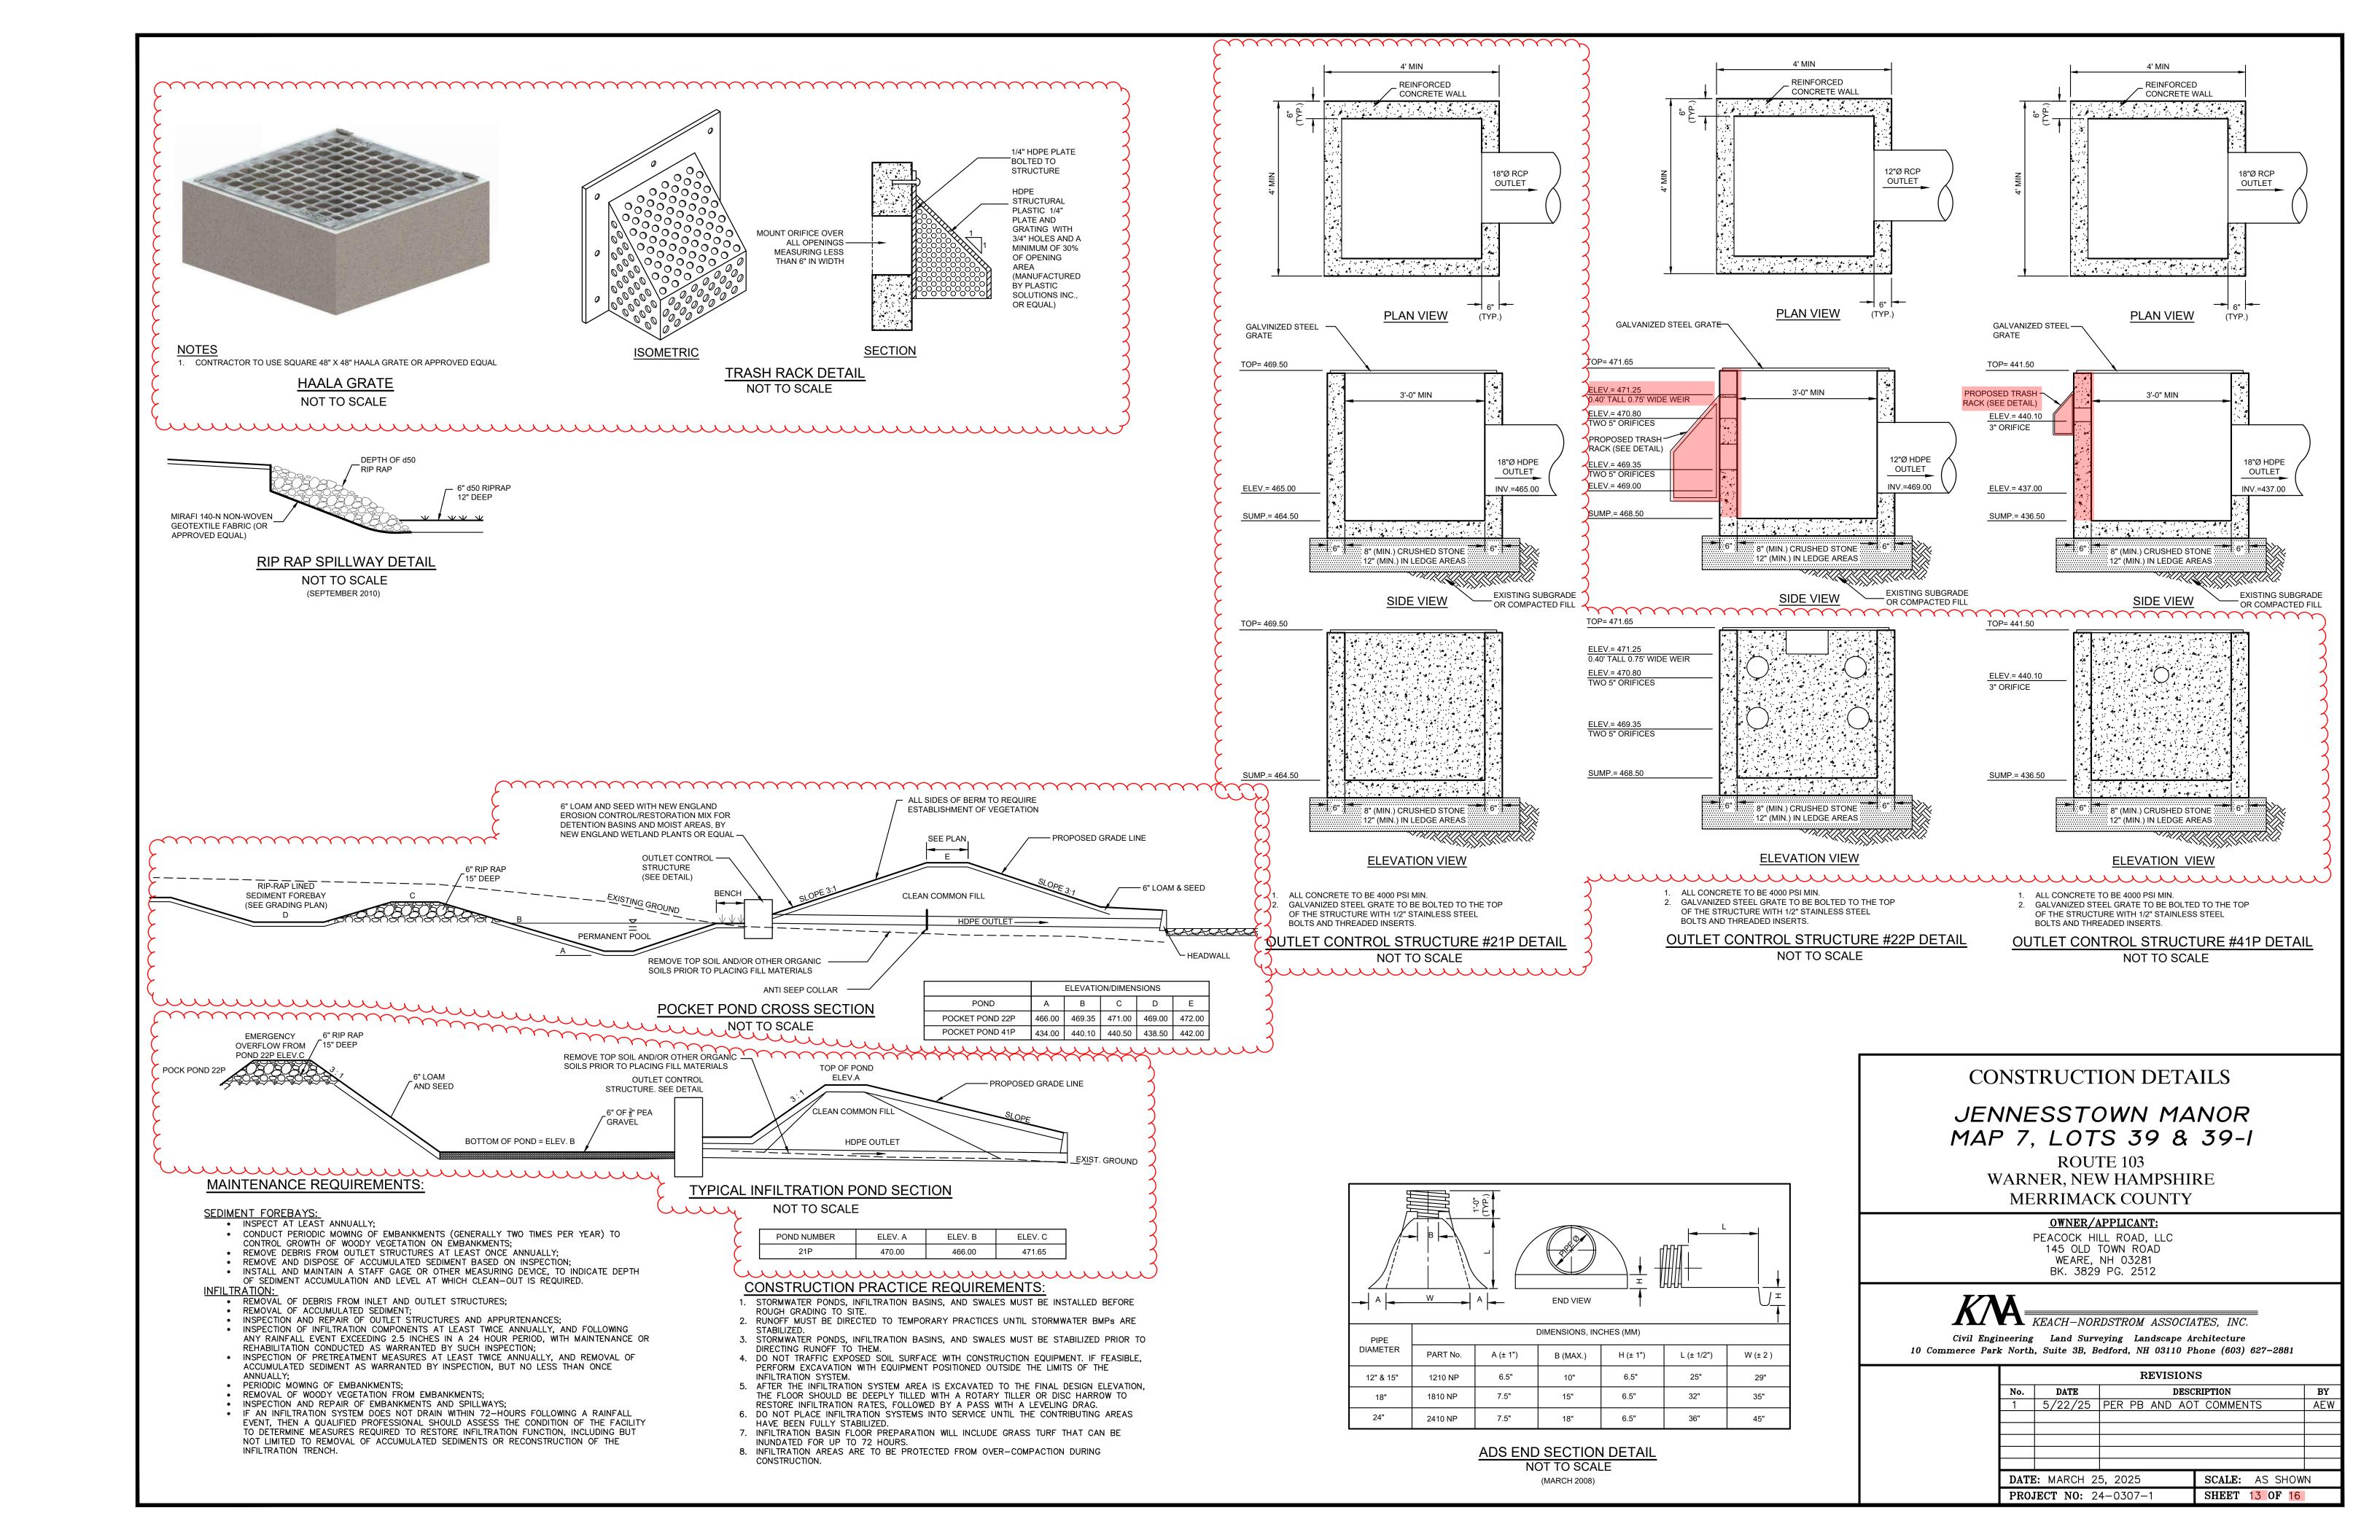

GRADATION OF	GRADATION OF STONE FOR LEVEL SPREADER BERM				
SIEVE DESIGNATION	PERCENT BY WEIGHT PASSING SQUARE MESH SIEVES				
12 INCH	100%				
6 INCH	84 - 100%				
3 INCH	68 - 83%				
1 INCH	42 - 55%				
NO. 4	8 - 12%				

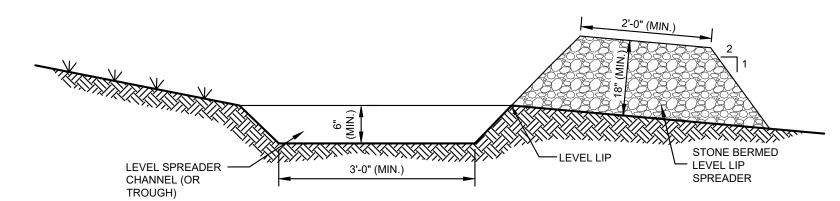


- 1. CONSTRUCT THE LEVEL SPREADER LIP ON A ZERO PERCENT GRADE TO INSURE UNIFORM SPREADING OF RUN-OFF. 2. LEVEL SPREADER SHALL BE CONSTRUCTED ON UNDISTURBED
- SOIL AND NOT ON FILL 3. THE FLOW FROM THE LEVEL SPREADER SHALL OUTLET INTO STABILIZED AREAS. WATER SHOULD NOT RECONCENTRATE IMMEDIATELY BELOW THE SPREADER.
- 4. PERIODIC INSPECTION AND REQUIRED MAINTENANCE SHALL BE PERFORMED.

MAINTENANCE REQUIREMENTS:

- 1. INSPECT AT LEAST ONCE ANNUALLY FOR ACCUMULATION OF SEDIMENT AND DEBRIS AND FOR SIGNS OF EROSION WITHIN APPROACH CHANNEL, SPREADER CHANNEL OR DOWN-SLOPE
- OF THE SPREADER. REMOVE DEBRIS WHENEVER OBSERVED DURING INSPECTION. REMOVE SEDIMENT WHEN ACCUMULATION EXCEEDS 25% OF
- SPREADER CHANNEL DEPTH. MOW AS REQUIRED BY LANDSCAPE DESIGN. AT A MINIMUM, MOW ANNUALLY TO CONTROL WOODY VEGETATION WITHIN THE
- 5. SNOW SHOULD NOT BE STORED WITHIN OR DOWN-SLOPE OF
- THE LEVEL SPREADER OR ITS APPROACH CHANNEL. 6. REPAIR ANY EROSION AND RE-GRADE OR REPLACE STONE BERM MATERIAL, AS WARRANTED BY INSPECTION.
- 7. RECONSTRUCT THE SPREADER IF DOWN-SLOPE CHANNELIZATION INDICATES THAT THE SPREADER IS NOT LEVEL OR THAT DISCHARGE HAS BECOME CONCENTRATED, AND CORRECTIONS CANNOT BE MADE THROUGH MINOR

STONED BERMED LEVEL LIP SPREADER DETAIL

NOT TO SCALE

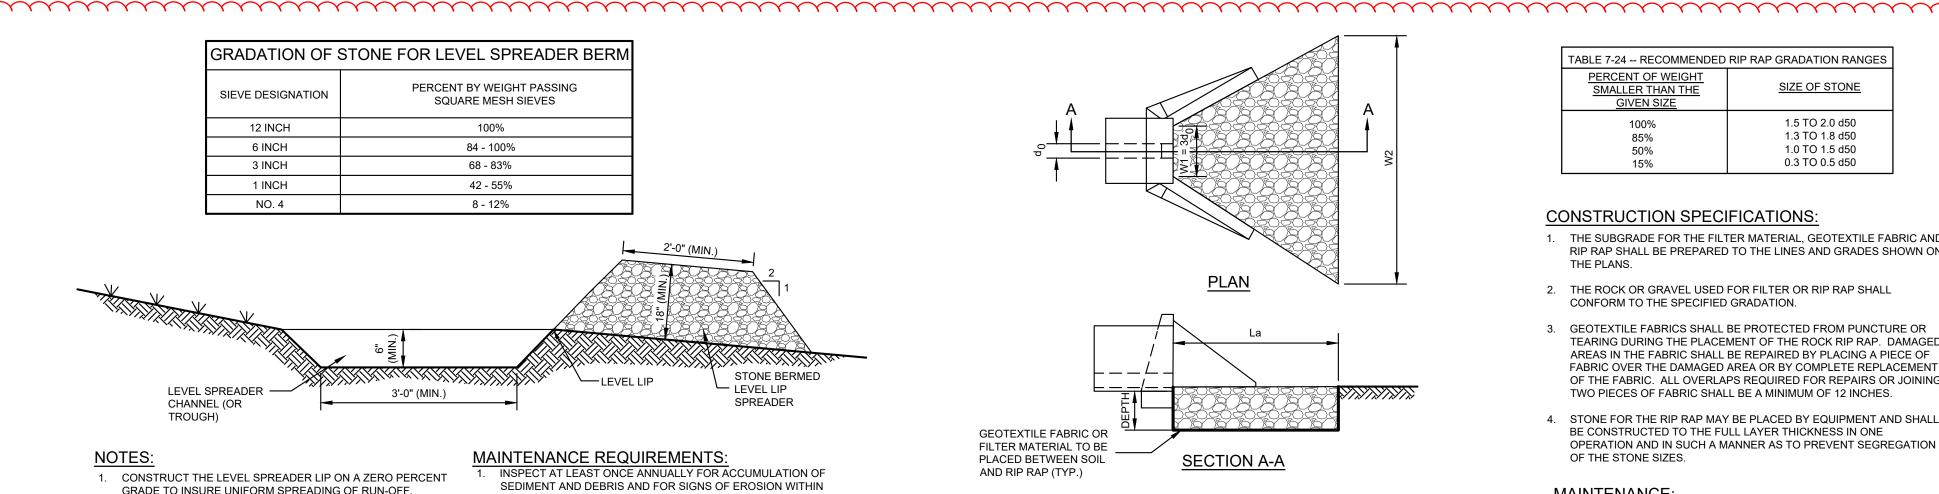

PIPE OUTLET TO FLAT AREA WITH NO DEFINED CHANNEL NOT TO SCALE

(MARCH 2008)

	ELEVATION/DIMENSIONS				
LOCATION	LENGTH FT	W1 FT	W2 FT	d50 IN.	DEPTH IN.
OCKET POND 41P OUTLET	11	5	16	4	6
NFILTRATION POND 21P OUTLET	13	5	18	5	8
OCKET POND 22P OUTLET	13	3	16	6	9
MH 211P OUTLET (HW #210)	14	5	19	3	6
	ALL LOCATIONS USE			6	9


TABLE 7-24 RECOMMENDED	RIP RAP GRADATION RANGES
PERCENT OF WEIGHT SMALLER THAN THE GIVEN SIZE	SIZE OF STONE
100% 85% 50% 15%	1.5 TO 2.0 d50 1.3 TO 1.8 d50 1.0 TO 1.5 d50 0.3 TO 0.5 d50

CONSTRUCTION SPECIFICATIONS:

- 1. THE SUBGRADE FOR THE FILTER MATERIAL, GEOTEXTILE FABRIC AND RIP RAP SHALL BE PREPARED TO THE LINES AND GRADES SHOWN ON
- 2. THE ROCK OR GRAVEL USED FOR FILTER OR RIP RAP SHALL CONFORM TO THE SPECIFIED GRADATION.
- 3. GEOTEXTILE FABRICS SHALL BE PROTECTED FROM PUNCTURE OR TEARING DURING THE PLACEMENT OF THE ROCK RIP RAP. DAMAGED AREAS IN THE FABRIC SHALL BE REPAIRED BY PLACING A PIECE OF FABRIC OVER THE DAMAGED AREA OR BY COMPLETE REPLACEMENT OF THE FABRIC. ALL OVERLAPS REQUIRED FOR REPAIRS OR JOINING TWO PIECES OF FABRIC SHALL BE A MINIMUM OF 12 INCHES.
- 4. STONE FOR THE RIP RAP MAY BE PLACED BY EQUIPMENT AND SHALL BE CONSTRUCTED TO THE FULL LAYER THICKNESS IN ONE OPERATION AND IN SUCH A MANNER AS TO PREVENT SEGREGATION OF THE STONE SIZES.

MAINTENANCE:

THE OUTLET PROTECTION SHOULD BE CHECKED AT LEAST ANNUALLY AND AFTER EVERY MAJOR RAIN EVENT. IF THE RIP RAP HAS BEEN DISPLACED, UNDERMINED, OR DAMAGED, IT SHOULD BE REPAIRED IMMEDIATELY. THE CHANNEL IMMEDIATELY BELOW THE OUTLET SHOULD BE CHECKED TO SEE THAT EROSION IS NOT OCCURRING. THE DOWNSTREAM CHANNEL SHOULD BE KEPT CLEAR OF OBSTRUCTIONS SUCH AS FALLEN TREES, DEBRIS, AND SEDIMENT THAT COULD CHANGE FLOW PATTERNS AND/OR TAILWATER DEPTHS ON THE PIPES. REPAIRS MUST BE CARRIED OUT IMMEDIATELY TO AVOID ADDITIONAL DAMAGE TO THE OUTLET PROTECTION APRON.

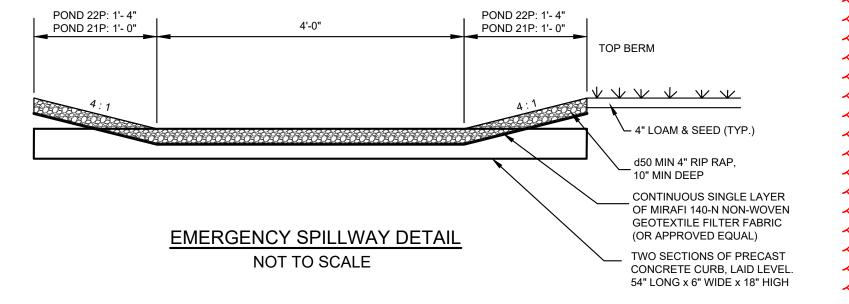

CONSTRUCTION DETAILS


JENNESSTOWN MANOR MAP 7, LOTS 39 & 39-1

> ROUTE 103 WARNER, NEW HAMPSHIRE MERRIMACK COUNTY

> > OWNER/APPLICANT:

PEACOCK HILL ROAD, LLC 145 OLD TOWN ROAD WEARE, NH 03281 BK. 3829 PG. 2512

		REVISION	S	
No.	DATE	DESC	RIPTION	BY
1	5/22/25	PER PB AND AO	T COMMENTS	AEW
DATE	E: MARCH 2	5, 2025	SCALE: AS SHOW	N
PRO.	JECT NO: 2	4-0307-1	SHEET 14 OF 16	

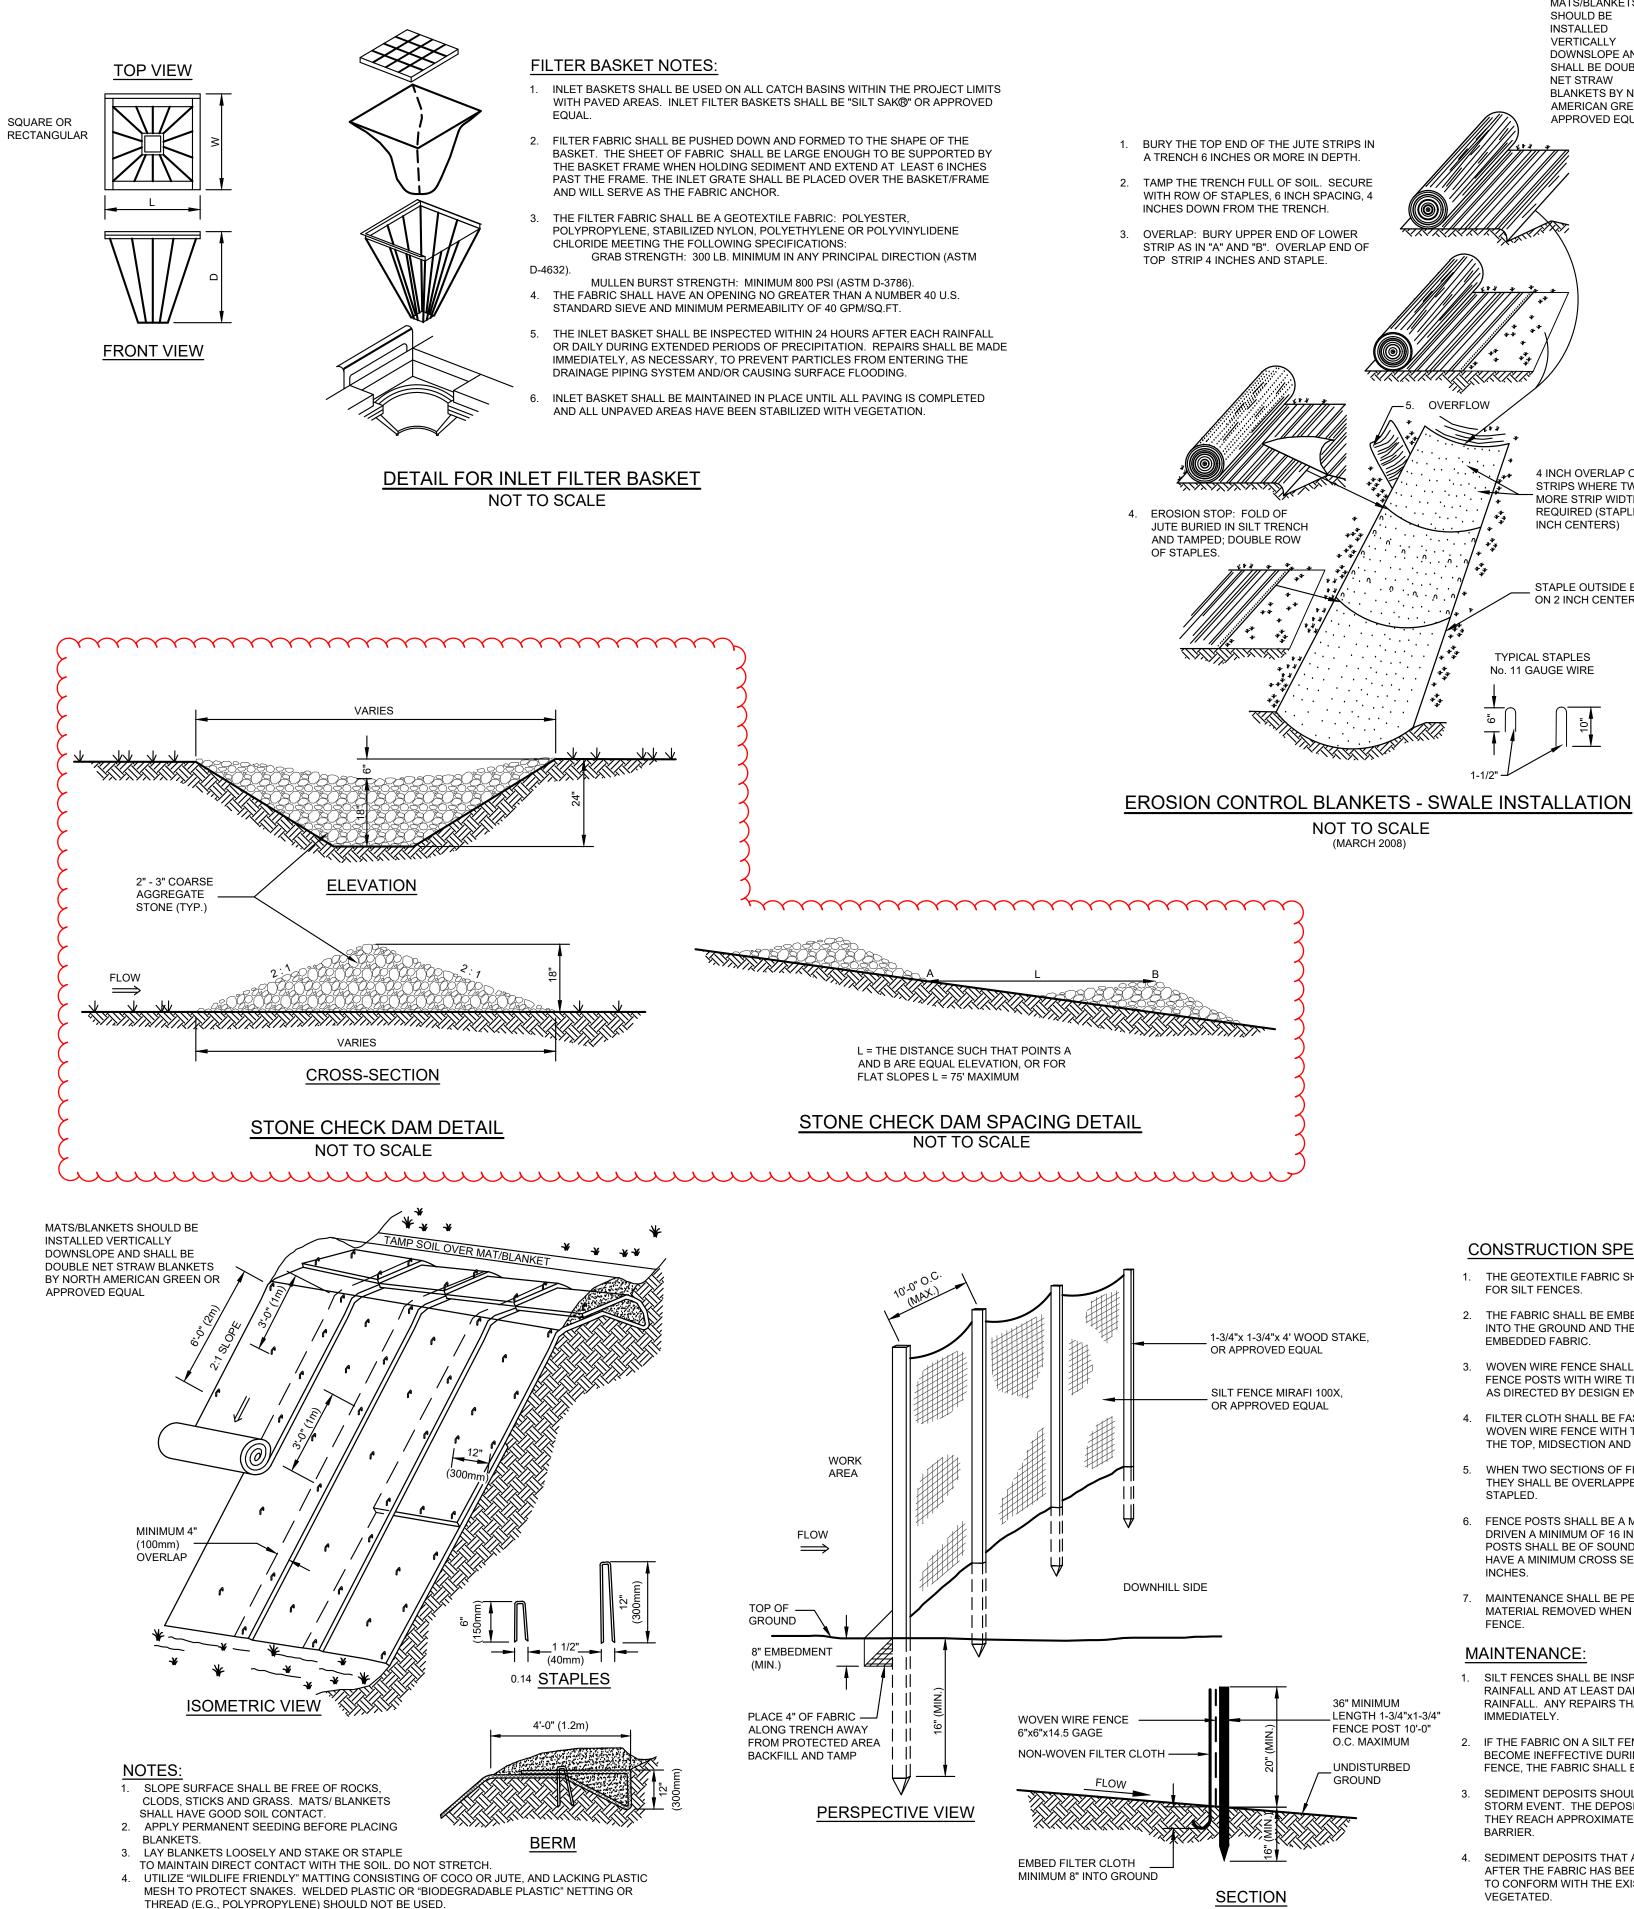

EROSION CONTROL BLANKETS - SLOPE INSTALLATION

NOT TO SCALE

MAINTENANCE:

MATS/BLANKETS SHOULD BE

DOWNSLOPE AND

SHALL BE DOUBLE

BLANKETS BY NORTH

AMERICAN GREEN OR

APPROVED EQUAL

4 INCH OVERLAP OF JUTE

STRIPS WHERE TWO OR

STAPLE OUTSIDE EDGE

ON 2 INCH CENTERS

TYPICAL STAPLES

No. 11 GAUGE WIRE

INCH CENTERS)

MORE STRIP WIDTHS ARE

REQUIRED (STAPLE ON 18

INSTALLED

VERTICALLY

NET STRAW


MUD AND SOIL PARTICLES WILL EVENTUALLY CLOG THE VOIDS IN THE CRUSHED STONE AND THE EFFECTIVENESS OF THE CRUSHED STONE PAD WILL NOT BE SATISFACTORY. WHEN THIS OCCURS, THE PAD SHOULD BE TOPDRESSED WITH NEW CRUSHED STONE OR COMPLETE REPLACEMENT OF THE PAD MAY BE NECESSARY WHEN THE PAD BECOMES COMPLETELY

IF WASHING FACILITIES ARE USED, THE SEDIMENT TRAPS SHOULD BE CLEANED OUT AS OFTEN AS NECESSARY TO ASSURE THAT ADEQUATE TRAPPING EFFICIENCY AND STORAGE VOLUME IS AVAILABLE. VEGETATIVE FILTER STRIPS SHOULD BE MAINTAINED TO INSURE A VIGOROUS STAND OF VEGETATION AT ALL TIMES.

CONSTRUCTION SPECIFICATIONS:

STONE FOR A STABILIZED CONSTRUCTION EXIT SHALL BE 3 INCH STONE, RECLAIMED STONE OR RECYCLED CONCRETE EQUIVALENT.

- 2. THE LENGTH OF THE STABILIZED EXIT SHALL NOT BE LESS THAN 50 FEET, EXCEPT FOR A SINGLE RESIDENTIAL LOT WHERE A 30 FOOT MINIMUM LENGTH WOULD APPLY.
- 3. THE THICKNESS OF THE STONE FOR THE STABILIZED EXIT SHALL NOT BE LESS THAN 6
- 4. THE WIDTH OF THE EXIT SHALL NOT BE LESS THAN THE FULL WIDTH OF THE AREA WHERE INGRESS OR EGRESS OCCURS OR 10 FEET, WHICHEVER IS GREATER.
- 5. GEOTEXTILE FILTER CLOTH SHALL BE PLACED OVER THE ENTIRE AREA PRIOR TO PLACING THE STONE. FILTER CLOTH IS NOT REQUIRED FOR A SINGLE FAMILY
- 6. ALL SURFACE WATER THAT IS FLOWING TO OR DIVERTED TOWARD THE CONSTRUCTION EXIT SHALL BE PIPED BENEATH THE EXIT. IF PIPING IS IMPRACTICAL, A BERM WITH 5:1 SLOPES THAT CAN BE CROSSED BY VEHICLES MAY BE SUBSTITUTED FOR THE PIPE.
- 7. THE EXIT SHALL BE MAINTAINED IN A CONDITION THAT WILL PREVENT TRACKING OR FLOWING OF SEDIMENT ONTO PUBLIC RIGHTS-OF-WAY. THIS MAY REQUIRE PERIODIC. TOPDRESSING WITH ADDITIONAL STONE AS CONDITIONS DEMAND AND REPAIR AND/OR CLEANOUT OF ANY MEASURES USED TO TRAP SEDIMENT. ALL SEDIMENT SPILLED, WASHED OR TRACKED ONTO PUBLIC RIGHT-OF-WAY MUST BE REMOVED PROMPTLY.
- WHEELS SHALL BE CLEANED TO REMOVE MUD PRIOR TO ENTRANCE ONTO PUBLIC RIGHTS-OF-WAY . WHEN WASHING IS REQUIRED, IT SHALL BE DONE ON AN AREA STABILIZED WITH STONE WHICH DRAINS INTO AN APPROVED SEDIMENT TRAPPING

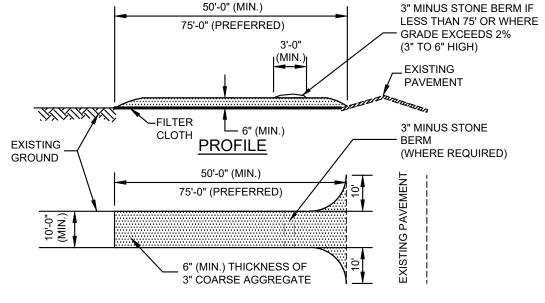

PLAN VIEW

STABILIZED CONSTRUCTION EXIT DETAIL

NOT TO SCALE (APRIL 2018)

CONSTRUCTION SPECIFICATIONS:

- THE GEOTEXTILE FABRIC SHALL MEET THE DESIGN CRITERIA FOR SILT FENCES.
- 2. THE FABRIC SHALL BE EMBEDDED A MINIMUM OF 8 INCHES INTO THE GROUND AND THE SOIL COMPACTED OVER THE EMBEDDED FABRIC
- WOVEN WIRE FENCE SHALL BE FASTENED SECURELY TO THE FENCE POSTS WITH WIRE TIE OR STAPLES WHERE NOTED OR AS DIRECTED BY DESIGN ENGINEER.

4. FILTER CLOTH SHALL BE FASTENED SECURELY TO THE

- WOVEN WIRE FENCE WITH TIES SPACED EVERY 24 INCHES AT THE TOP, MIDSECTION AND BOTTOM. WHEN TWO SECTIONS OF FILTER CLOTH ADJOIN EACH OTHER,
- THEY SHALL BE OVERLAPPED BY 6 INCHES, FOLDED AND FENCE POSTS SHALL BE A MINIMUM OF 36 INCHES LONG AND
- DRIVEN A MINIMUM OF 16 INCHES INTO THE GROUND. WOOD POSTS SHALL BE OF SOUND QUALITY HARDWOOD AND SHALL HAVE A MINIMUM CROSS SECTIONAL AREA OF 3.0 SQUARE
- MAINTENANCE SHALL BE PERFORMED AS NEEDED AND MATERIAL REMOVED WHEN "BULGES" DEVELOP IN THE SILT


MAINTENANCE


SILT FENCE DETAIL

NOT TO SCALE

(MARCH 2008)

- 1. SILT FENCES SHALL BE INSPECTED IMMEDIATELY AFTER EACH RAINFALL AND AT LEAST DAILY DURING PROLONGED RAINFALL. ANY REPAIRS THAT ARE REQUIRED SHALL BE MADE
- IF THE FABRIC ON A SILT FENCE SHOULD DECOMPOSE OR BECOME INEFFECTIVE DURING THE EXPECTED LIFE OF THE FENCE, THE FABRIC SHALL BE REPLACED PROMPTLY.
- SEDIMENT DEPOSITS SHOULD BE INSPECTED AFTER EVERY STORM EVENT. THE DEPOSITS SHOULD BE REMOVED WHEN THEY REACH APPROXIMATELY ONE-HALF THE HEIGHT OF THE
- SEDIMENT DEPOSITS THAT ARE REMOVED OR LEFT IN PLACE AFTER THE FABRIC HAS BEEN REMOVED SHALL BE GRADED TO CONFORM WITH THE EXISTING TOPOGRAPHY AND

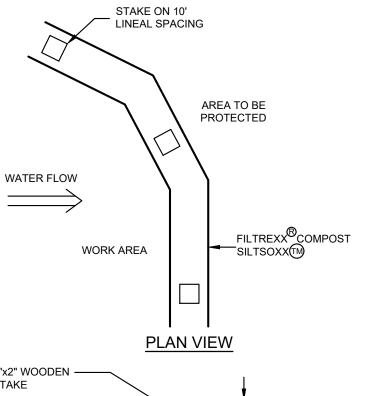

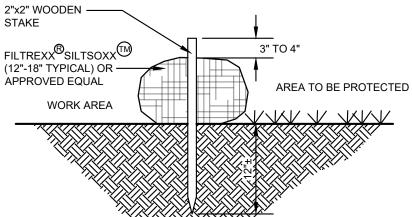

SECTION VIEW

ALL MATERIAL TO MEET FILTREXX® SPECIFICATIONS.

- SILTSOXX COMPOST/SOIL/ROCK/SEED FILL TO MEET APPLICATION REQUIREMENTS.
- SILTSOXX DEPICTED IS FOR MINIMUM SLOPES. GREAT SLOPES MAY REQUIRE LARGER SOCKS PER THE ENGINEER.
- 4. COMPOST MATERIAL TO BE DISPERSED ON SITE, AS DETERMINED

FILTREXX[®] SILTSOXX[™]DETAIL NOT TO SCALE

CONSTRUCTION SEQUENCE

- FIRST CUT AND CLEAR TREES AND BRUSH ONLY WITHIN DESIGNATED LIMITS OF CLEARING AS NECESSARY TO FACILITATE PROPOSED CONSTRUCTION. ALL TREES, BRANCHES AND OTHER VEGETATIVE MATERIALS SHALL BE PROPERLY DISPOSED OF OFF SITE BY THE CONTRACTOR. THIS PROJECT IS MANAGED TO MEET THE
- REQUIREMENTS AND INTENT OF RSA 430:53 AND AGR 3800 RELATIVE TO INVASIVE SPECIES. 2. PRIOR TO COMMENCEMENT OF ANY EARTHMOVING OPERATIONS, ALL APPLICABLE TEMPORARY EROSION CONTROL MEASURES, INCLUDING SPECIFIED PERIMETER SILTATION FENCING AND STABILIZED CONSTRUCTION EXIT SHALL
- BE IN PLACE AS SHOWN ON THE PROJECT PLANS 3. COMPLETE GRUBBING OPERATIONS. ALL STUMPS AND SIMILAR ORGANIC DEBRIS SHALL BE PROPERLY DISPOSED OF BY THE CONTRACTOR. NATIVE ORGANIC SOIL MATERIALS SUITABLE FOR USE AS TOPSOIL SHALL BE STOCKPILED WITHIN AREAS OUT OF THE WAY OF OTHER CONSTRUCTIONS ACTIVITIES AND DRAINAGE FLOW. STOCKPILES SHALL BE TEMPORARILY SEEDED WITH WINTER RYE AND BE SURROUNDED WITH HAY BALES AND/OR FABRIC SILTATION FENCE IN ORDER TO PREVENT LOSS DUE TO EROSION.
- 4. BEGIN EARTHMOVING OPERATIONS, COMMENCING WITH WORK NEEDED TO BALANCE SITE AND FACILITATE BUILDING FOUNDATION AND RETAINING WALL CONSTRUCTION. PERMANENT DOWNSLOPE WORK SHALL BE PROTECTED FROM UPGRADIENT STORMWATER FLOW BY THE CONSTRUCTION OF TEMPORARY EARTHEN DIKES OR
- EXCAVATED SWALES. 5. ONCE BUILDING FOUNDATION WORK IS UNDERWAY, CONTINUE EARTHMOVING OPERATIONS UNTIL DESIGN
- SUBGRADE IS ACHIEVED 6. INSTALL DRAINAGE SWALE SYSTEMS AND OTHER UTILITIES WORKING FROM LOW TO HIGH. INCOMPLETE WORK SHALL BE PROTECTED FROM SILTATION BY THE USE OF SILTATION BARRIERS AROUND SWALES UNTIL THE SITE HAS
- BECOME FULLY STABILIZED 7. PLACE GRAVEL AND CRUSHED GRAVEL OVER PROPOSED DRIVEWAY, WALKS AND PARKING AREAS AND COMPACT
- IN SPECIFIED LIFT THICKNESS 8. COMPLETE EXCAVATION/STABILIZATION GRADING ACTIVITIES. WHEN COMPLETE, IMMEDIATELY BEGIN TOPSOILING
- PROPOSED TURF AREAS USING STOCKPILED LOAM SUPPLEMENTED WITH BORROW LOAM, IF NECESSARY, TO
- LEAVE A THICKNESS OF 4 INCHES OF FRIABLE LOAM. 9. FINE GRADE ALL FUTURE TURF AREAS AND HYDROSEED WITH THE SPECIFIED SEED MIXTURE IMMEDIATELY AFTER
- FINE GRADING IS COMPLETED. ALL AREAS SHALL BE STABILIZED WITHIN 72 HOURS OF ACHIEVING FINISH GRADE. 10. INSTALL THE BINDER COURSE OF PAVEMENT OVER ALL DESIGNATED AREAS.
- 11. CONTINUE TO MONITOR AND RECTIFY MINOR SITE AND SLOPE EROSION UNTIL ENTIRE SITE APPEARS TO BE COMPLETELY STABILIZED AND VEGETATED WITH A HEALTHY STAND OF TURF OR GROUND COVER. MAINTAIN
- SPECIFIED SILTATION/EROSION CONTROL MEASURES THROUGH ONE WINTER. 12. INSTALL THE SPECIFIED WEARING COURSE OF PAVEMENT OVER THE BINDER COURSE

13. COMPLETE INSTALLATION OF LANDSCAPING, SIGNAGE AND OTHER SITE AMENITIES.

EROSION CONTROL NOTES

- 1. EXPOSED EARTHWORK SHALL BE CONFINED TO AS LIMITED AN AREA AS IS PRACTICAL AT ANY GIVEN TIME THROUGHOUT THE CONSTRUCTION SEQUENCE. AT NO TIME SHALL MORE THAN FIVE (5) ACRES OF SITE AREA BE IN AN UNSTABLE CONDITION. NO GIVEN AREA OF THE SITE SHALL BE LEFT IN AN UNSTABILIZED CONDITION FOR A PERIOD OF TIME EXCEEDING THIRTY (30) CALENDAR DAYS.
- 2. TEMPORARY EROSION CONTROL MEASURES SHALL BE INSTALLED IN STRICT ACCORDANCE WITH PROJECT PLANS. IN ADDITION, SIMILAR MEASURES SHALL BE INSTALLED WHERE AND WHEN THE FIELD CONDITION, OR FIELD OPERATION OF THE INDIVIDUAL SITE CONTRACTOR, MAY WARRANT. ALL TEMPORARY EROSION CONTROL MEASURES USED SHALL BE INSPECTED WEEKLY AND WITHIN 24 HOURS AFTER 0.25" OF RAINFALL OR MORE. THEY SHALL BE CLEANED AND MAINTAINED AND OTHERWISE KEPT IN AN EFFECTIVE OPERATING MANNER THROUGHOUT
- THE CONSTRUCTION PERIOD ALL DISTURBED AREAS DESIGNATED TO BE TURF, SHALL RECEIVE A MINIMUM APPLICATION OF 4 INCHES OF LOAM
- (COMPACTED THICKNESS), PRIOR TO FINAL SEEDING AND MULCHING. 4. ALL SWALES AND DITCHLINES SHALL BE PERIODICALLY CLEANED OF DEPOSITED SEDIMENT SO AS TO MAINTAIN AN EFFECTIVE GRADE AND CROSS SECTION. ALL SWALES AND DITCHLINES SHALL BE FULLY STABILIZED PRIOR TO
- HAVING STORMWATER DIRECTED TOWARDS THEM. 5. IN THE EVENT THAT, DURING CONSTRUCTION OF ANY PORTION OF THIS PROJECT, A WINTER SHUTDOWN IS NECESSARY, THE CONTRACTOR SHALL STABILIZE ALL INCOMPLETE WORK AND PROVIDE FOR SUITABLE METHODS OF DIVERTING RUNOFF IN ORDER TO ELIMINATE SHEET FLOW ACROSS FROZEN SURFACES.
- AN AREA SHALL BE CONSIDERED STABLE IF ONE OF THE FOLLOWING HAS OCCURRED:
 - A. BASE COURSE GRAVELS ARE INSTALLED IN AREAS TO BE PAVED;
 - B. A MINIMUM OF 85% VEGETATED GROWTH HAS BEEN ESTABLISHED; C. A MINIMUM OF 3" OF NON-EROSIVE MATERIAL SUCH AS STONE OR RIP RAP HAS BEEN INSTALLED; OR EROSION CONTROL BLANKETS HAVE BEEN PROPERLY INSTALLED.
- 7. DUST SHALL BE CONTROLLED BY THE USE OF WATER AS NECESSARY THROUGHOUT THE CONSTRUCTION PERIOD, IN ACCORDANCE WITH ENV-A 1000 8. IN NO WAY ARE THOSE TEMPORARY EROSION CONTROL MEASURES INDICATED ON THESE PLANS TO BE
- CONSIDERED ALL INCLUSIVE. THE CONTRACTOR SHALL USE JUDGEMENT IN INSTALLING SUPPLEMENTARY EROSION CONTROL MEASURES WHERE AND WHEN SPECIFIC SITE CONDITIONS AND/OR CONSTRUCTION
- 9. AREAS HAVING FINISH GRADE SLOPES OF 3:1 OR STEEPER, SHALL BE STABILIZED WITH JUTE MATTING WHEN AND IF FIELD CONDITIONS WARRANT, OR IF SO ORDERED. JUTE MATTING INSTALLED TO CONFORM WITH THE RECOMMENDED BEST MANAGEMENT PRACTICE OUTLINED IN VOLUME 3 OF THE NEW HAMPSHIRE STORMWATER MANUAL "EROSION AND SEDIMENT CONTROLS DURING CONSTRUCTION."
- 10. ALL DETENTION PONDS AND TREATMENT SWALES SHALL BE CONSTRUCTED PRIOR TO ANY EARTH MOVING
- ACTIVITIES THAT WILL INFLUENCE STORMWATER RUNOFF. 11. ALL ROADWAYS AND PARKING AREAS SHALL BE STABILIZED WITHIN 72 HOURS OF ACHIEVING FINISHED GRADE.
- 12. ALL CUT AND FILL SLOPES SHALL BE STABILIZED WITHIN 72 HOURS OF ACHIEVING FINISHED GRADE.

WINTER CONSTRUCTION NOTES:

- ALL PROPOSED POST-DEVELOPMENT VEGETATED AREAS WHICH DO NOT EXHIBIT A MINIMUM OF 85% VEGETATIVE GROWTH BY OCTOBER 15TH, OR WHICH ARE DISTURBED AFTER OCTOBER 15TH, SHALL BE STABILIZED BY SEEDING AND INSTALLING EROSION CONTROL BLANKETS ON SLOPES GREATER THAN 4:1, AND SEEDING AND PLACING 3 TO 4 TONS OF MULCH PER ACRE. SECURED WITH ANCHORED NETTING. ELSEWHERE. THE PLACEMENT OF EROSION CONTROL BLANKETS OR MULCH AND NETTING SHALL NOT OCCUR OVER ACCUMULATED SNOW OR ON FROZEN GROUND AND SHALL BE COMPLETED IN ADVANCE OF THAW OR SPRING MELT
- 2. ALL DITCHES OR SWALES WHICH DO NOT EXHIBIT A MINIMUM OF 85% VEGETATIVE GROWTH BY OCTOBER 15TH, OR WHICH ARE DISTURBED AFTER OCTOBER 15TH, SHALL BE STABILIZED WITH STONE OR EROSION CONTROL BLANKETS APPROPRIATE FOR THE DESIGN FLOW CONDITIONS.
- 3. AFTER OCTOBER 15TH, INCOMPLETE ROAD OR PARKING SURFACES SHALL BE PROTECTED WITH A MINIMUM OF 3 INCHES OF CRUSHED GRAVEL PER NHDOT ITEM 304.3 OR. IF CONSTRUCTION IS TO CONTINUE THROUGH THE WINTER SEASON, BE CLEARED OF ANY
- ACCUMULATED SNOW AFTER EACH STORM EVENT. 4. AN AREA SHALL BE CONSIDERED STABLE IF ONE OF THE FOLLOWING HAS OCCURRED:
 - A. BASE COURSE GRAVELS ARE INSTALLED IN AREAS TO BE PAVED: B A MINIMUM OF 85% VEGETATED GROWTH HAS BEEN ESTABLISHED.
 - . A MINIMUM OF 3" OF NON-EROSIVE MATERIAL SUCH AS STONE OR RIP RAP HAS
 - BEEN INSTALLED; OR
 - D. EROSION CONTROL BLANKETS HAVE BEEN PROPERLY INSTALLED.

CONSTRUCTION DETAILS

JENNESSTOWN MANOR MAP 7, LOTS 39 & 39-1

ROUTE 103 WARNER, NEW HAMPSHIRE MERRIMACK COUNTY


OWNER/APPLICANT:

PEACOCK HILL ROAD, LLC 145 OLD TOWN ROAD WEARE, NH 03281 BK. 3829 PG. 2512



KEACH-NORDSTROM ASSOCIATES, INC.

	REVISIONS				
No.	DATE	DESC	RIPTION	BY	
1	5/22/25	PER PB AND AO	T COMMENTS	AΕ\	
DATI	E: MARCH 2	5, 2025	SCALE: AS SHOW	/N	
PRO.	JECT NO: 2	4-0307-1	SHEET 15 OF 16		

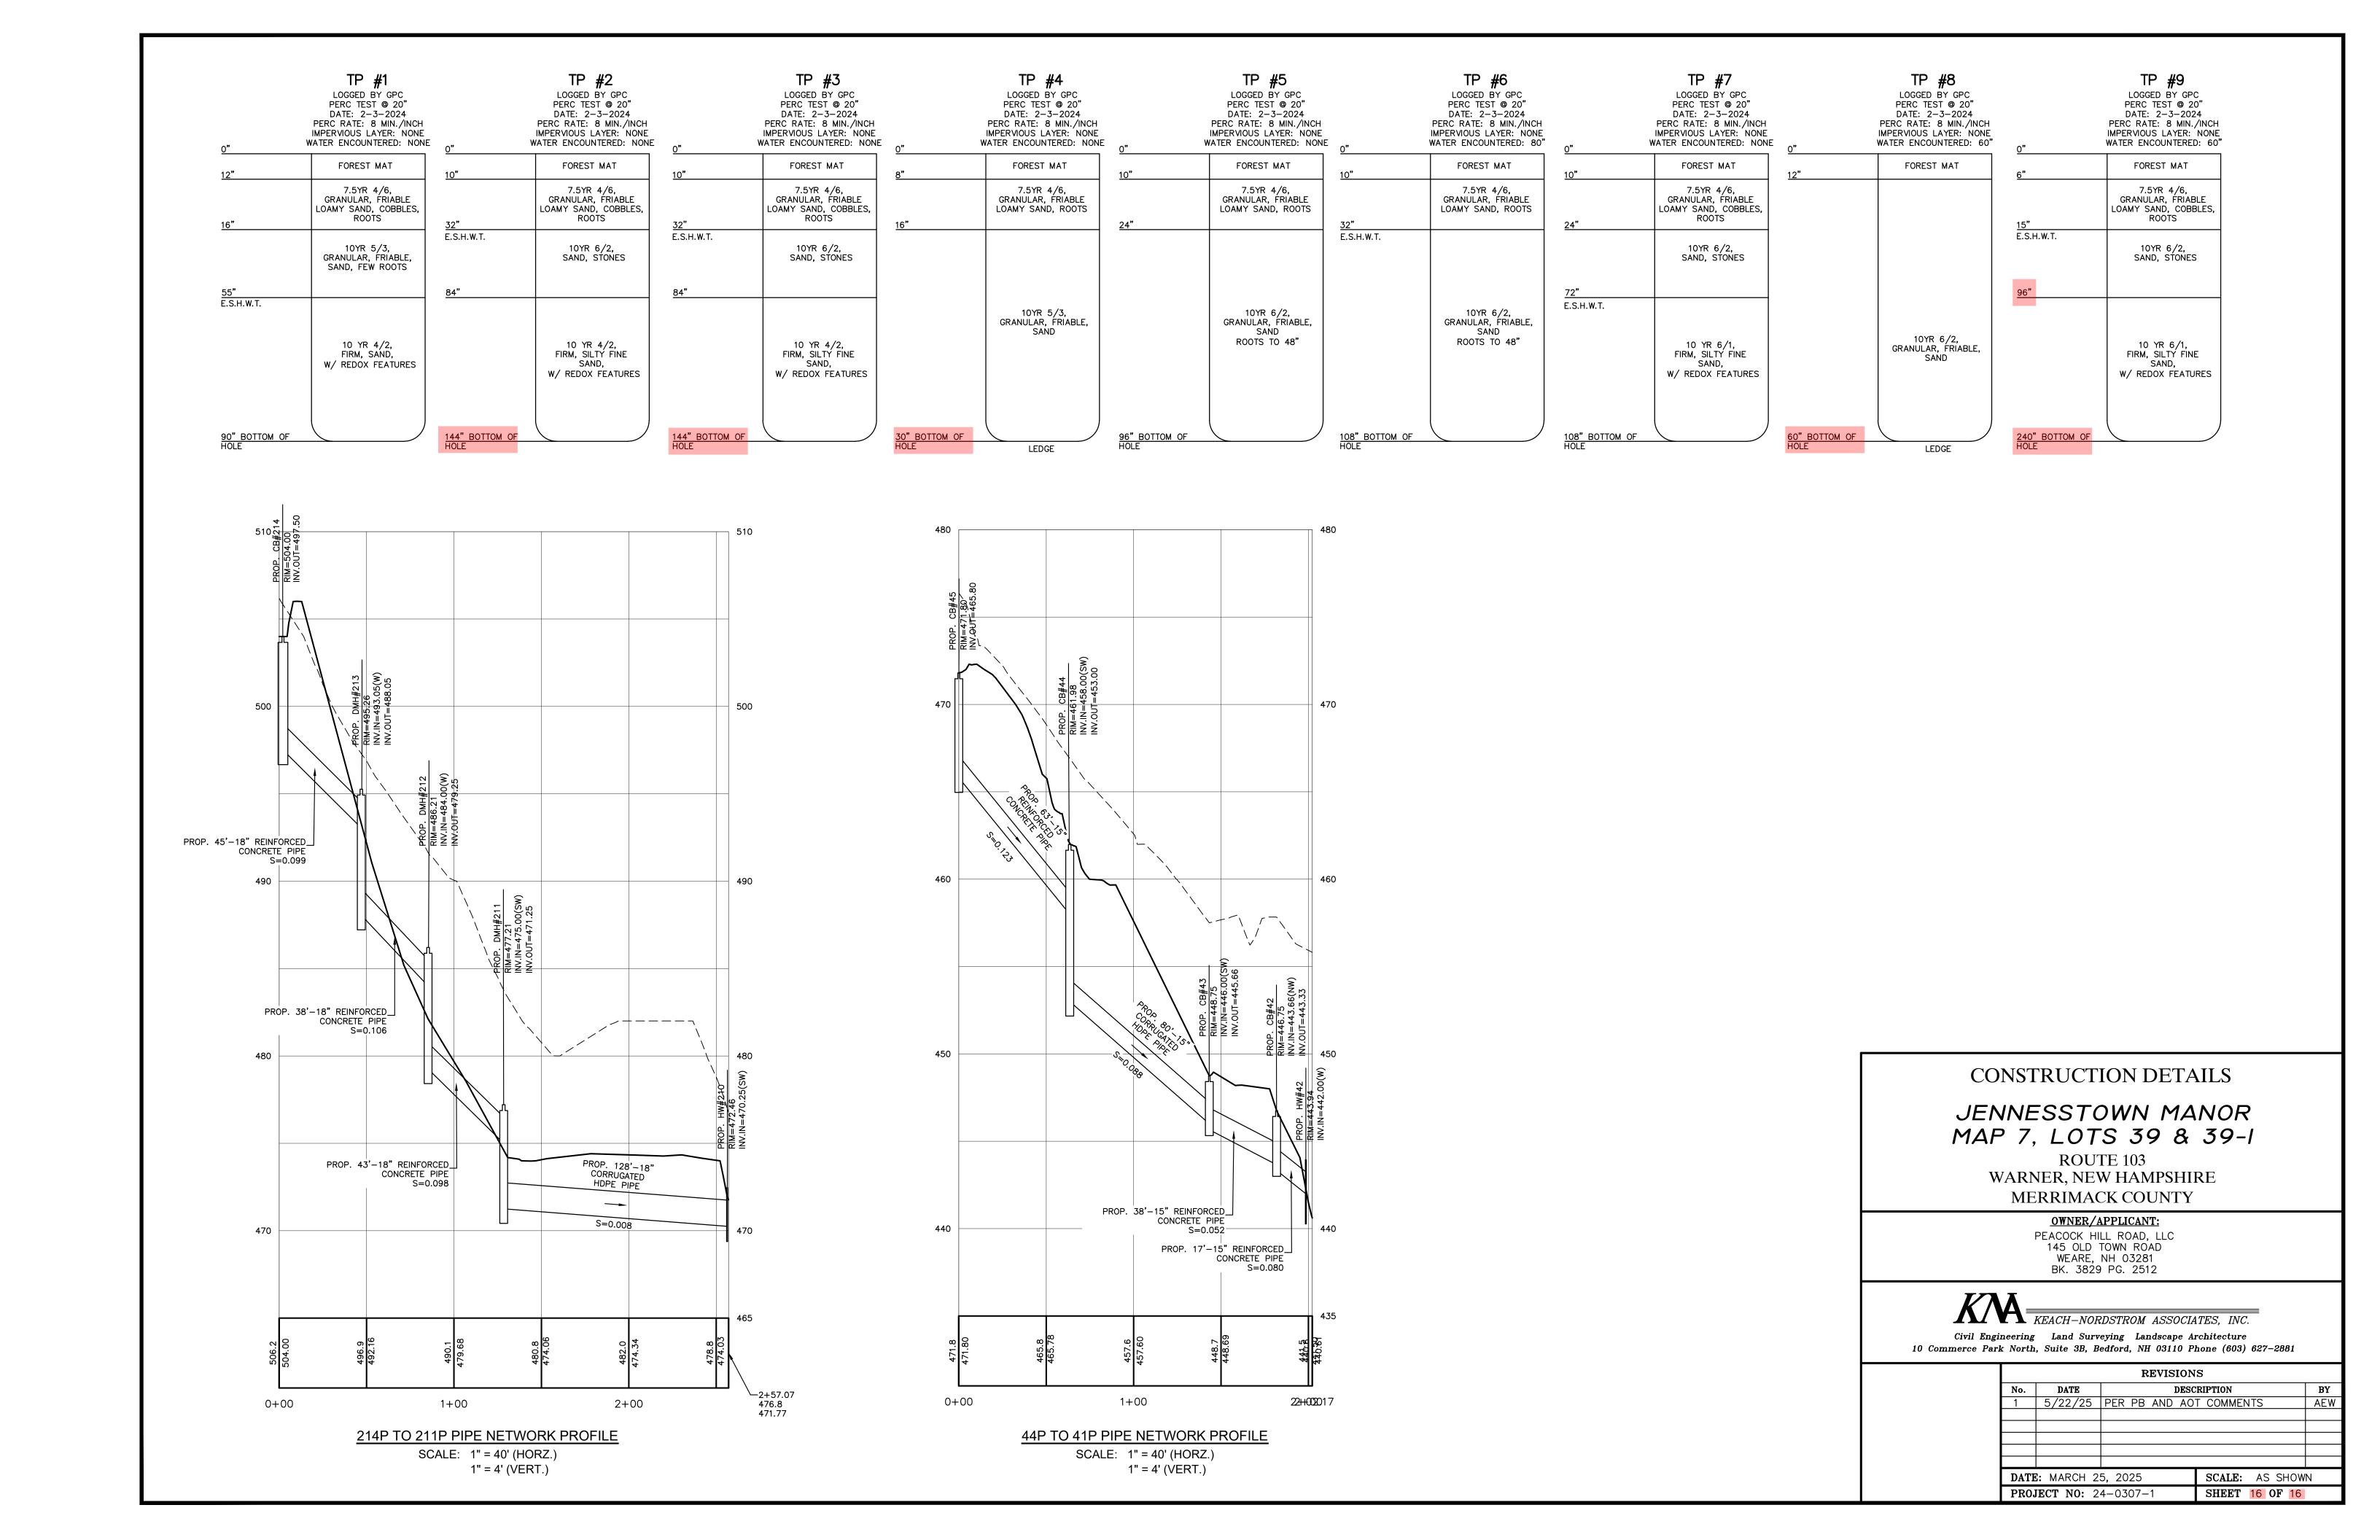





| 6'-0" → 6'-0" →

plywood sheathing

1/2" fire rated





| ← 6'-0" → | ← 6'-0" → |

plywood sheathing

1/2" fire rated

FRONT ELEVATION

SCALE: 1/8"=1'-0"

| ← 6'-0" → | ← 6'-0" → |

plywood sheathing

1/2" fire rated

0302 DESIGN SOLUTIONS
SA MELVIN, LLC
ONT VERNON, NH 0305
03-235-4246

FOR: PREPARED F 4 UNIT DWEI

REVISIONS

1-26-2025 SCALE: AS NOTED DRAWN BY: LAM JOB NO.: FIT-2501

A-'

2. 8" CONCRETE FOUNDATION WALL ON 2'-0"×1'-0" CONTINUOUS

RESIDENTIAL DESIGN SOLUTIONS
BY LISA MELVIN, LLC
PO BOX 548 MONT VERNON, NH 03057
603-235-4246

REPARED FOR: UNIT DWELLING


⊕ 4

REVISIONS

OUNDATION

DATE: 1-26-2025
SCALE: AS NOTE:
DRAWN BY: LAM

JOB NO.: FIT-2501

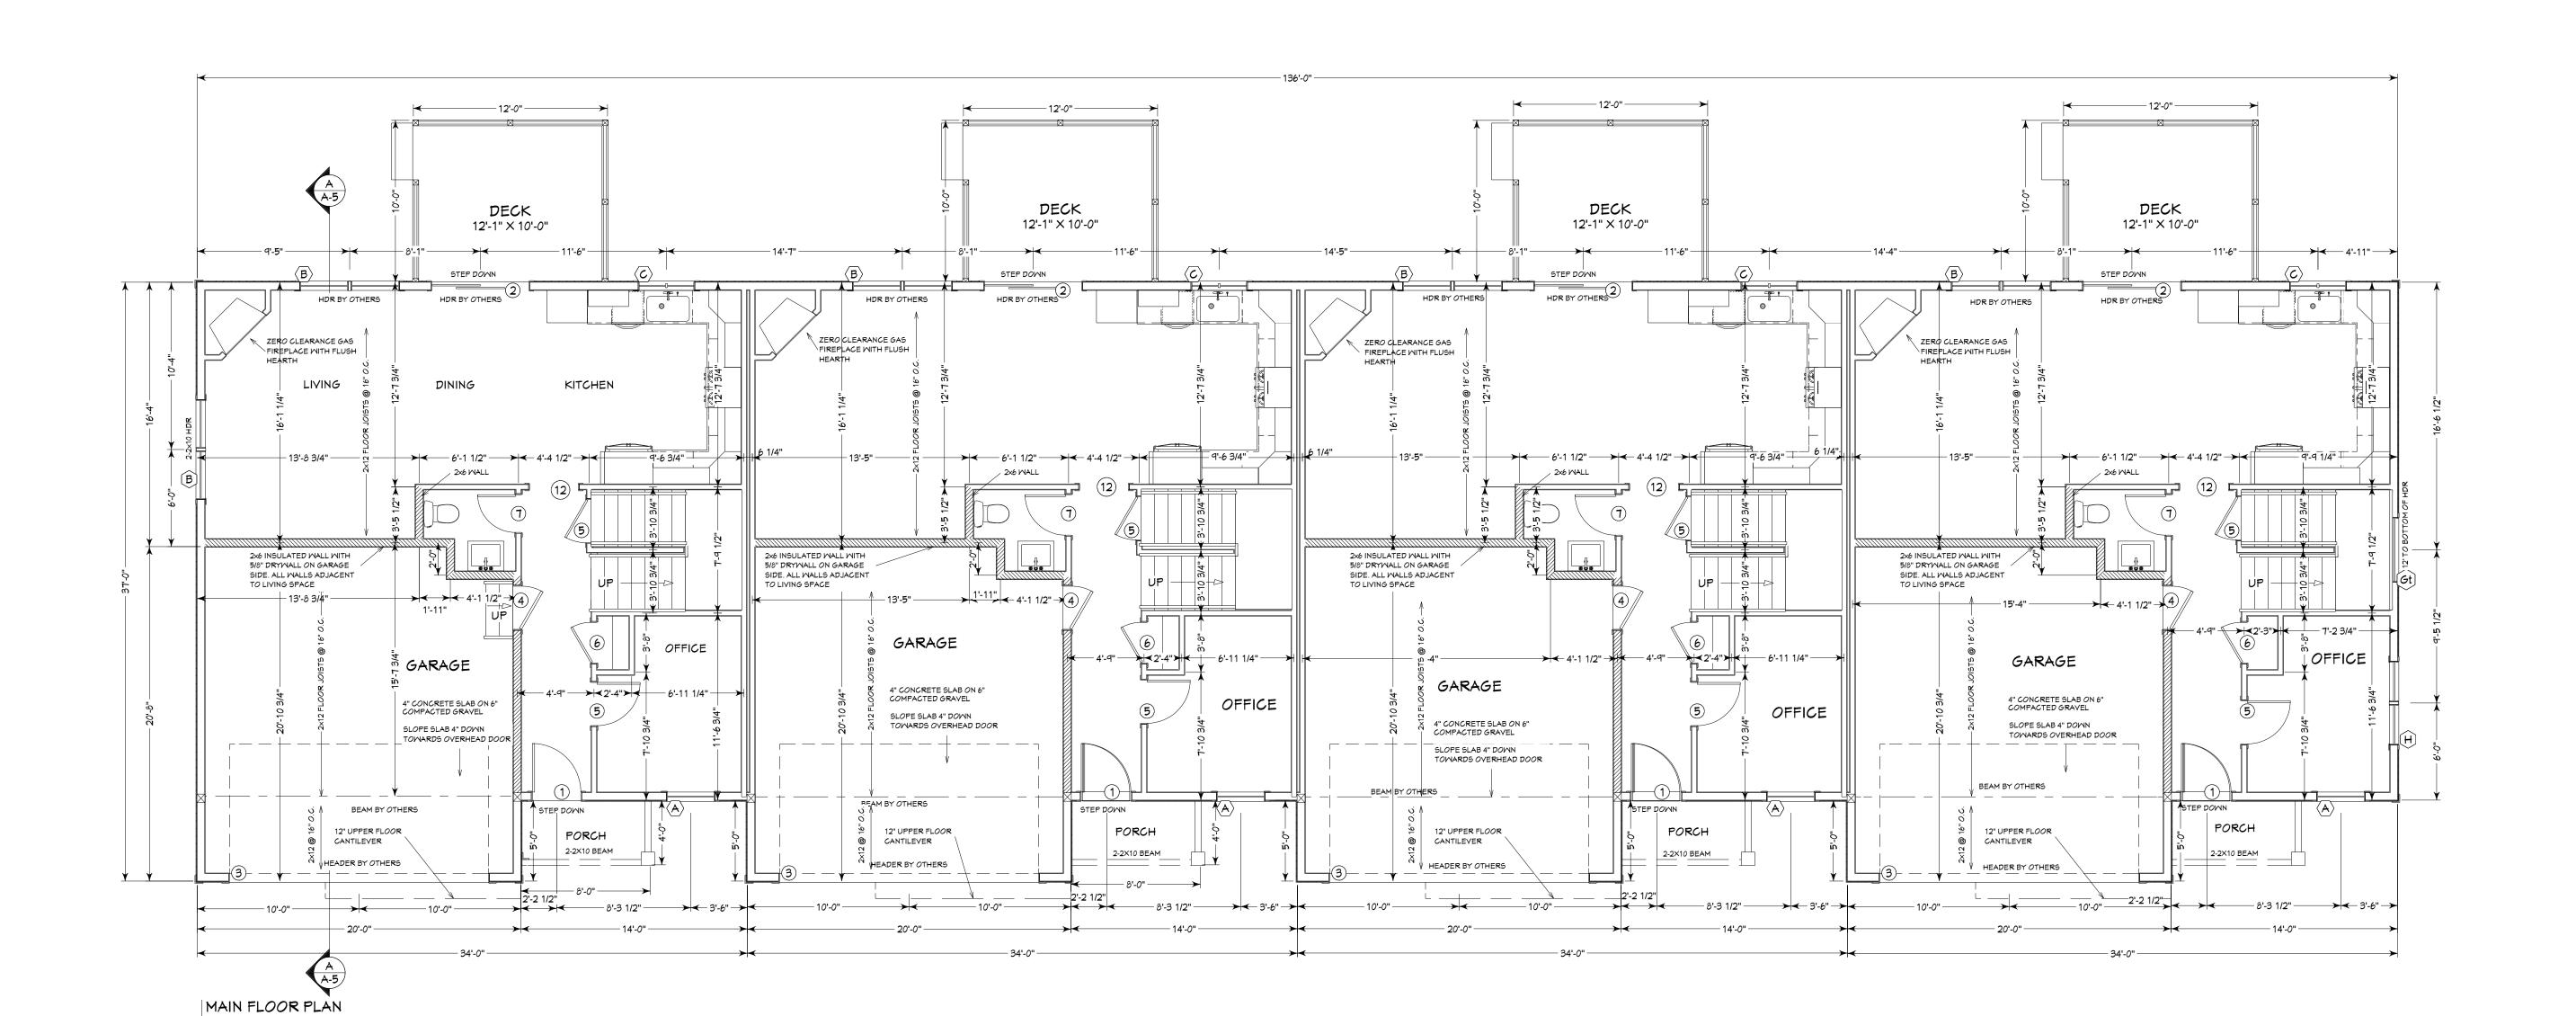

SCALE: 3/16"=1'-0" 795 SQUARE FEET CONDITIONED LIVING SPACE

1. 9'-0" PLATE HEIGHT

RESIDENTIAL DESIGN SOLUTIONS
BY LISA MELVIN, LLC
PO BOX 548 MONT VERNON, NH 0305
603-235-4246

PREPARED FOR: 4 UNIT DWELLING


REVISIONS

DATE: 1-26-2025

SCALE: AS NOTED

DRAWN BY: LAM

JOB NO.: FIT-2501

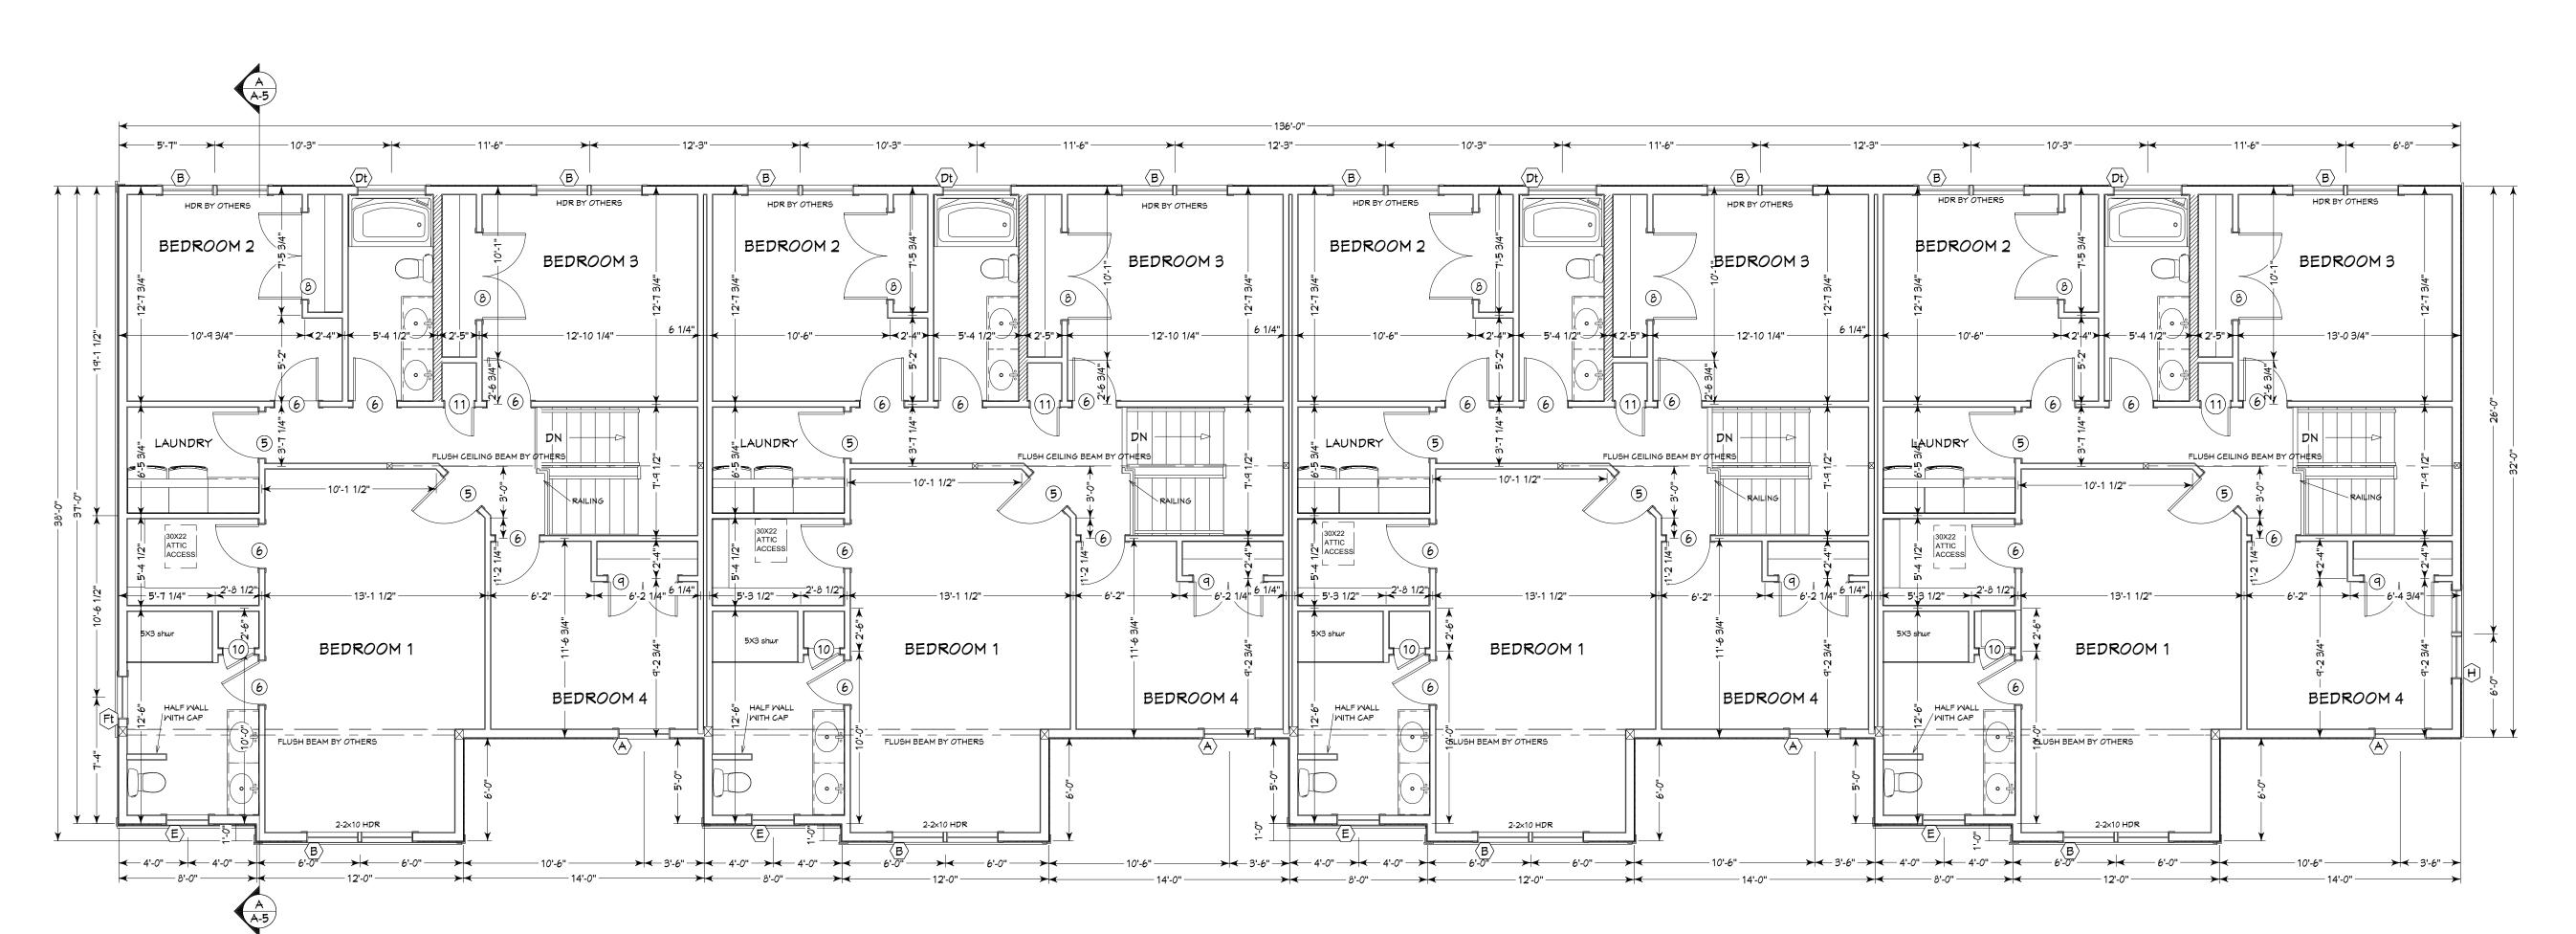

UPPER FLOOR PLAN

SCALE: 3/16"=1"-0" 1,095 SQUARE FEET CONDITIONED LIVING SPACE

1. 8'-0" PLATE HEIGHT
2. ALE EXTERIOR MINDOW HEADERS TO BE 2-2x8 UNLESS OTHERWISE

RESIDENTIAL DESIGN SOLUTIONS
BY LISA MELVIN, LLC
PO BOX 548 MONT VERNON, NH 030

PREPARED FOR: 4 UNIT DWELLING


REVISIONS


DATE: 1-26-2025


SCALE: AS NOTED

DRAWN BY: LAM

JOB NO.: FIT-2501

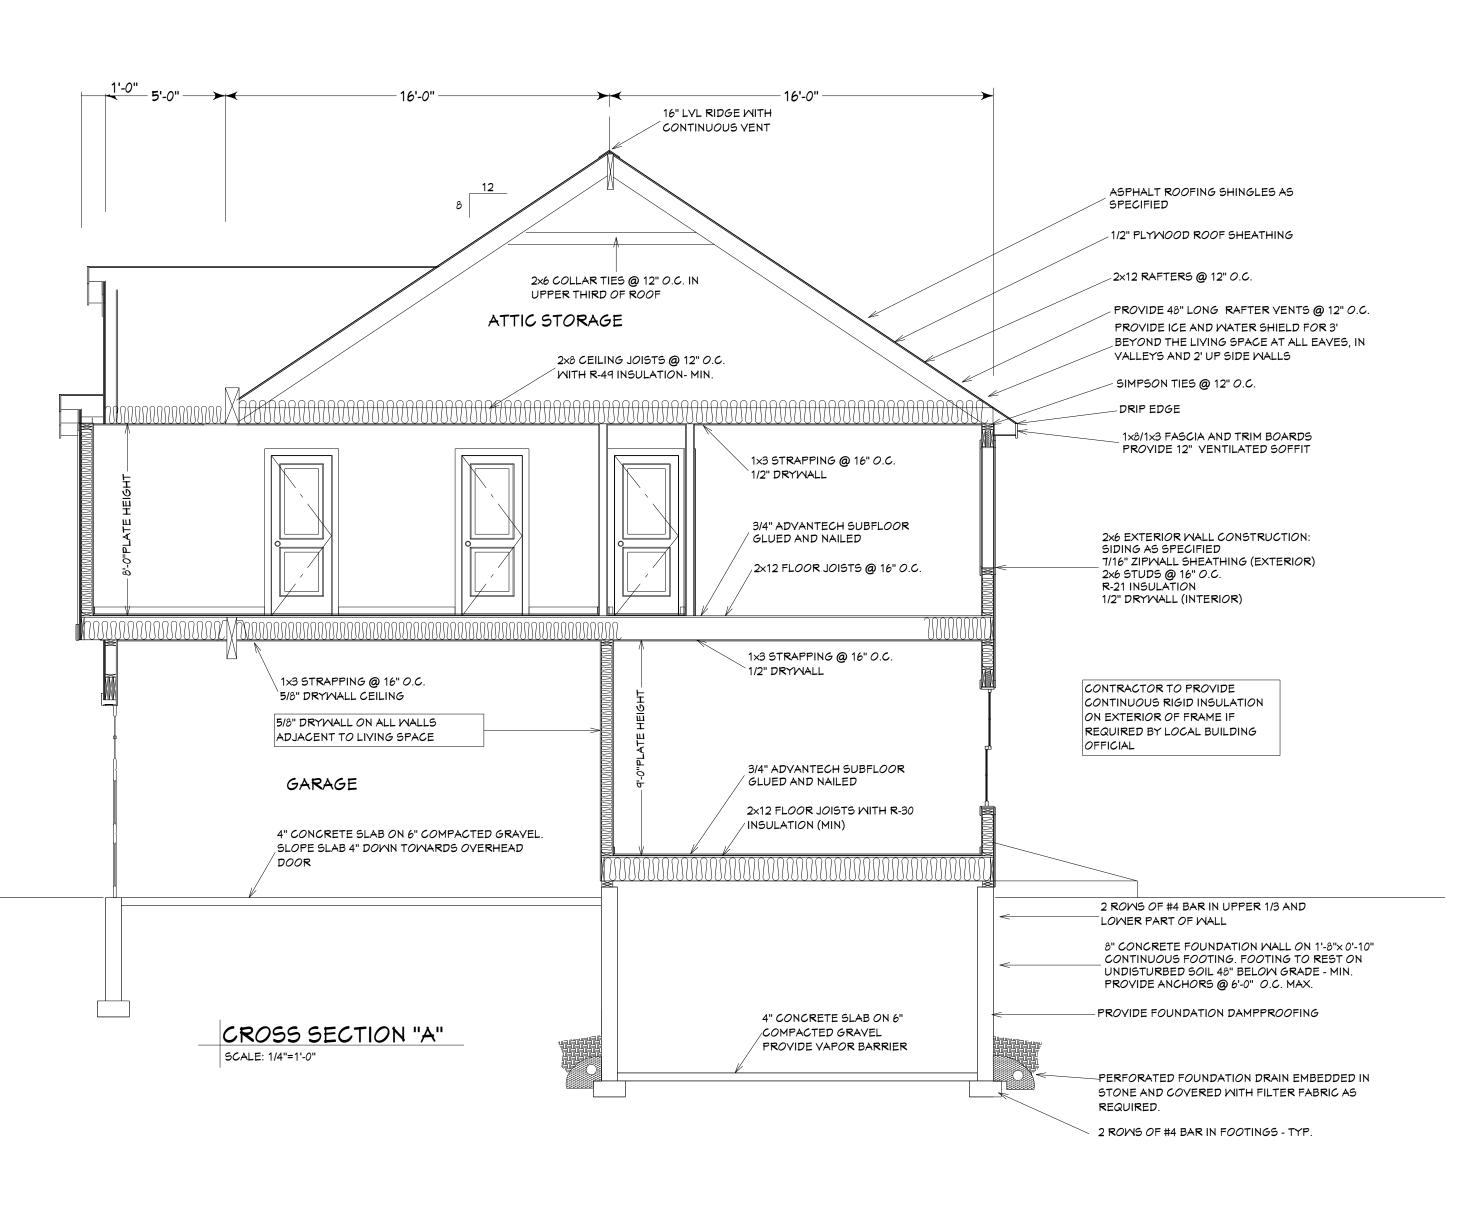

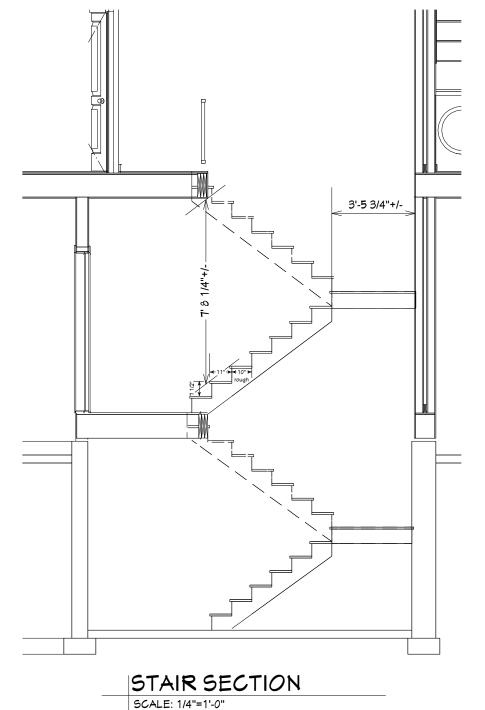

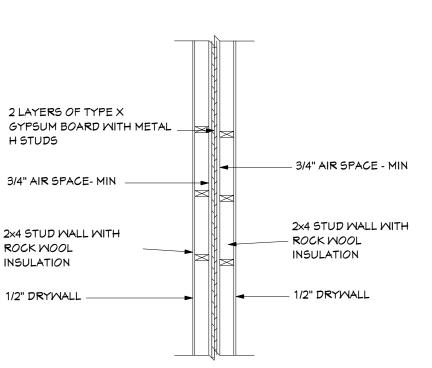


FIREMALL DETAIL

NOT TO SCALE (FIREWALL TO BE APPROVED BY LOCAL BUILDING OFFICIAL PRIOR TO CONSTRUCTION)

NOTE: SILLS OF ALL WINDOWS TO BE 24" ABOVE FLOOR (MIN.) IF THEY ARE HIGHER THAN 6'-0" ABOVE GRADE

Y	11141	JUY	I SCHEDUL	-5	
М	ARK	QTY	R.O.	DESIGNATION	DESCRIPTION
	$A \Big\rangle \Big $	8	36"×60"+/-		DOUBLE HUNG - EGRESS
	в	17	72"×60"+/-		MULLED DOUBLE HUNG- EGRESS
	$c angle \mid$	4	42"×42"+/-		DOUBLE CASEMENT
(1	Dt	4	48"×18"+/-		AMNING - TEMPERED
	E	4	30"×48"+/-		DOUBLE HUNG
	Ft〉	1	30"×48"+/-		DOUBLE HUNG - TEMPERED
$\overline{\langle}$	Gt	1	48"×60"+/-		FIXED - TEMPERED
$\overline{}$	$H \rangle$	2	60"×60"+/-		MULLED DOUBLE HUNG

MARK	QTY	SIZE	DESCRIPTION
1	4	3068	GLAZED ENTRY
(2)	4	6068	SLIDER
(3)	4	16'×8'	OVERHEAD GARAGE DOOR
(4)	4	2868	B-LABEL W/ SELF CLOSING HINGES
(5)	16	2868	INTERIOR
6	28	2668	INTERIOR
7	4	2468	INTERIOR
8	8	5068	INTERIOR DOUBLE
(q)	4	4068	INTERIOR DOUBLE
(10)	4	2068	INTERIOR
11)	4	1868	INTERIOR
(12)	4	3068	CASED OPENING

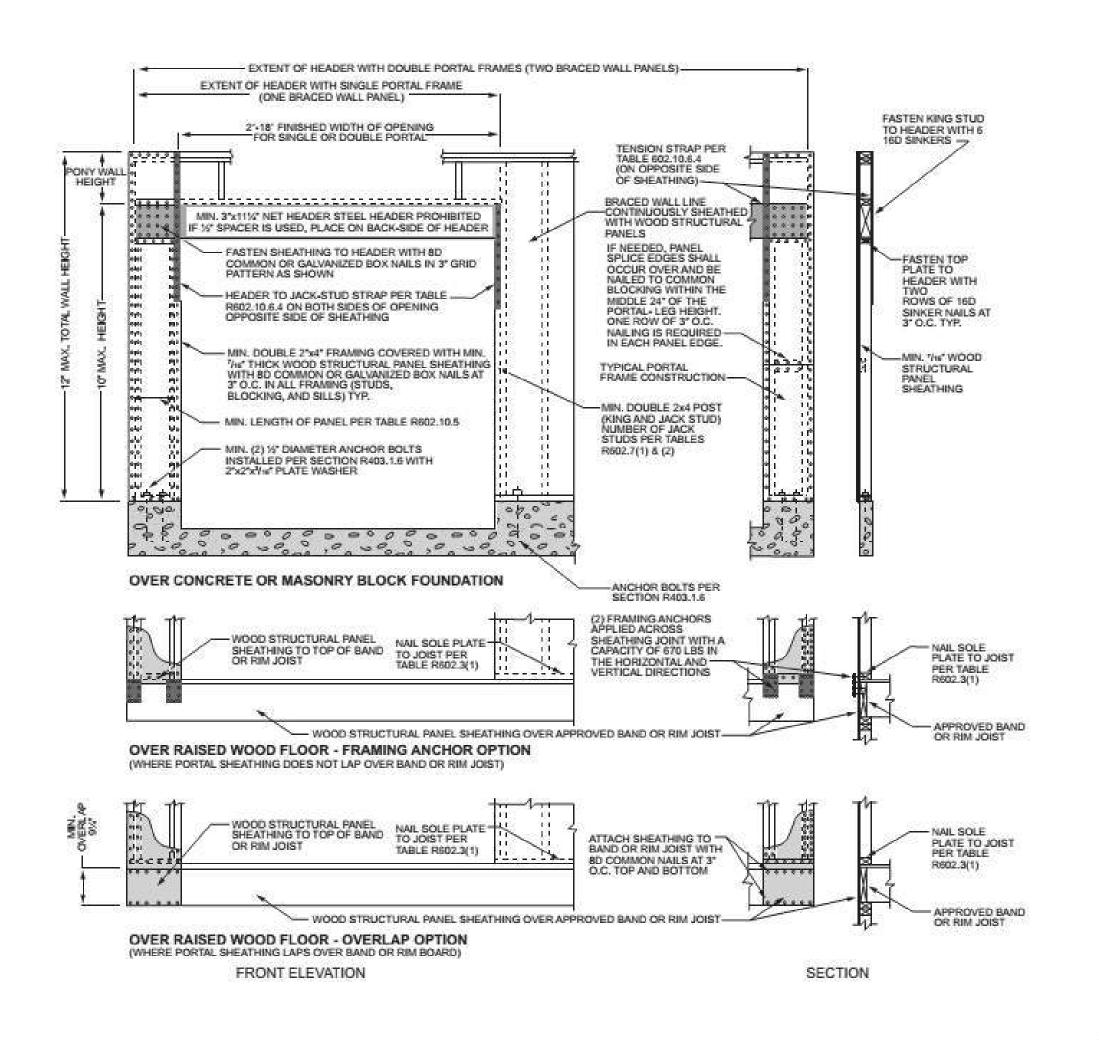

0

 ω

REVISIONS

1-26-2025 AS NOTED SCALE: DRAWN BY: LAM

JOB NO.: FIT-2501

O R L N

 \mathcal{D}

风田

REP,

(C) COPYRIGHT 2024 RESIDENTIAL DESIGN

SOLUTIONS BY L.M.